

OFFICE OF CAMPUS PLANNING & OPERATIONS

March 30th, 2022

ARCHITECTURAL REVIEW BOARD MEETING NOTIFICATION

Dear Chautauquan,

The owners of the Barge Residence at 4 Irving, in Neighborhood Traditional District are coming before the Architectural Review Board with a proposal for the improvement of a non-conforming foundation and porch to allow for the construction of a partial new foundation and 2nd floor porch. Therefore, this project requires an Architectural Review Board review for the following variance required for this scope of work.

Variances/Requests being considered:

- -Exceed the allowable impervious surface ratio (existing structure already exceeds the max. allow. ISR, but proposed new construction will actually DECREASE the ISR)
 (ALU 4.4.3)
- 2) Exceed the maximum allowable floor area ratio (F.A.R.) (existing structure already exceeds max. all. F.A.R.) (ALU 4.4.3)
- 3) -Improvements to a non-conforming foundation and porch within a 5'-0" rear yard Setback (ALU 4.4.6)
- 4) Improvements to a non-conforming foundation and porch less than 10'-0" from a neighboring Structure. (ALU 4.4.6)
- 5) Partial Demolition of the original partial foundation and porch deck and reconstruction using appropriate waterproofing membrane and flashings. (ALU 6.11.2)

You are receiving this notification because your property is approximately within 150' of the proposed project site.

Plans for this project may be reviewed online using the following link:

Architecture Review Board (ARB) News and Notes - Chautauqua Institution (chq.org)

The Architectural Review Board will meet on May 5th 2022 @ Noon via Zoom conference. See instructions for joining this conference below. Please submit any comments that you may have in writing for the Architectural Review Board's consideration. E-mails are preferred and may be submitted to the administrator of architectural and land use regulations at arb@chq.org until 12:00 noon on May 4th, 2022.

Join Zoom Meeting

https://us02web.zoom.us/j/87493286509?pwd=enY5dm9XU09Rdk5qVGhVSIRGUXIhUT09

Meeting ID: 874 9328 6509

Passcode: 0505 One tap mobile

+16468769923,,87493286509#,,,,*0505# US (New York) +13126266799,,87493286509#,,,,*0505# US (Chicago)

Dial by your location

- +1 646 876 9923 US (New York)
- +1 312 626 6799 US (Chicago)
- +1 301 715 8592 US (Washington DC)
- +1 669 900 6833 US (San Jose)
- +1 253 215 8782 US (Tacoma)
- +1 346 248 7799 US (Houston)
- +1 408 638 0968 US (San Jose)

Meeting ID: 874 9328 6509

Passcode: 0505

Find your local number: https://us02web.zoom.us/u/krZD9GoHy

Ryan B. Boughton, Assoc. AIA

Administrator of Architectural and Land Use Regulations

rboughton@chq.org | o: 716.357.6245

Chautauqua Institution

PO Box 28 | 1 Ames Ave. Chautauqua, NY 14722

chq.org | assembly.chq.org Office Phone: 716.357.6245


Fax: 716.357.9014

The Barge Residence


#4 Irving Place

Chautauqua Institution, Chautauqua, NY 14722



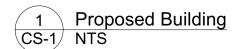



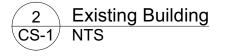

DRAWING INDEX:

-COVER SHEET

-SITE PLANS

ARCHITECTURAL

-FLOOR PLAN -ELEVATIONS

General Notes:

- All interior partitions are wood stud and 1/2 GWB construction unless noted otherwise.
- All dimensions are from face of stud or face of existing construction unless noted otherwise
- Provide and install sound attenuation batt insulation
- Maintain all required fire separations when penetrating rated assemblies
- Do not cut or patch structural members in a manner that will compromise the load capacity of any member.

Applicable Codes:

2020 Residential Code of New York State Single Family Home 2020 Fire Code of New York State

2020 Plumbing Code of New York State 2020 Mechanical Code of New York State

Chautauqua Institition - ALU-Regulations-Final-Nov2021

Neighborhood Traditional District - Zero rear and side yard setback

Neighborhood fraditional District - Zero real and side yard setback				
	Allowable	Existing	Proposed	
Min. Lot Width	40'-0"	40'-0"	40'-0"	
Min. Lot Area	2,000	2,000	2,000	
Maximum FAR	1.0	2.007	2.005	
Maximum ISR	75%	78.99%	77.90%	
Building Ht. Eave	24'-0"	Not Compliant	Not Changing	
Building Ht. Roof	36'-0"	Not Compliant	Not Changing	

Note - ISR increases is minor addition to first floor porch to simplify construction

- ISR decrease is the removal of a side yard basement entrance.
- ISR is a NET decrease

Proposed Floor Area Ratio's	Area	FAR	Exempt	Subtotal
Basement	1,408	.704	-	.704
First Floor	919	.459	-	.459
Second Floor	853	.426	-	.427
Third Floor	831	.415	-	.415
Total FAR				2.005

Note: - Minor Decrease in second floor FAR is the removal of the bay window




Mayville, New York 14757 Phone: 716-386-6228 Fax: 716-386-4159 E-mail: mbi@mayshark.com

Barghe and Kathe Steve

Drawn By 03.24.2022

Cover Sheet

CS-1

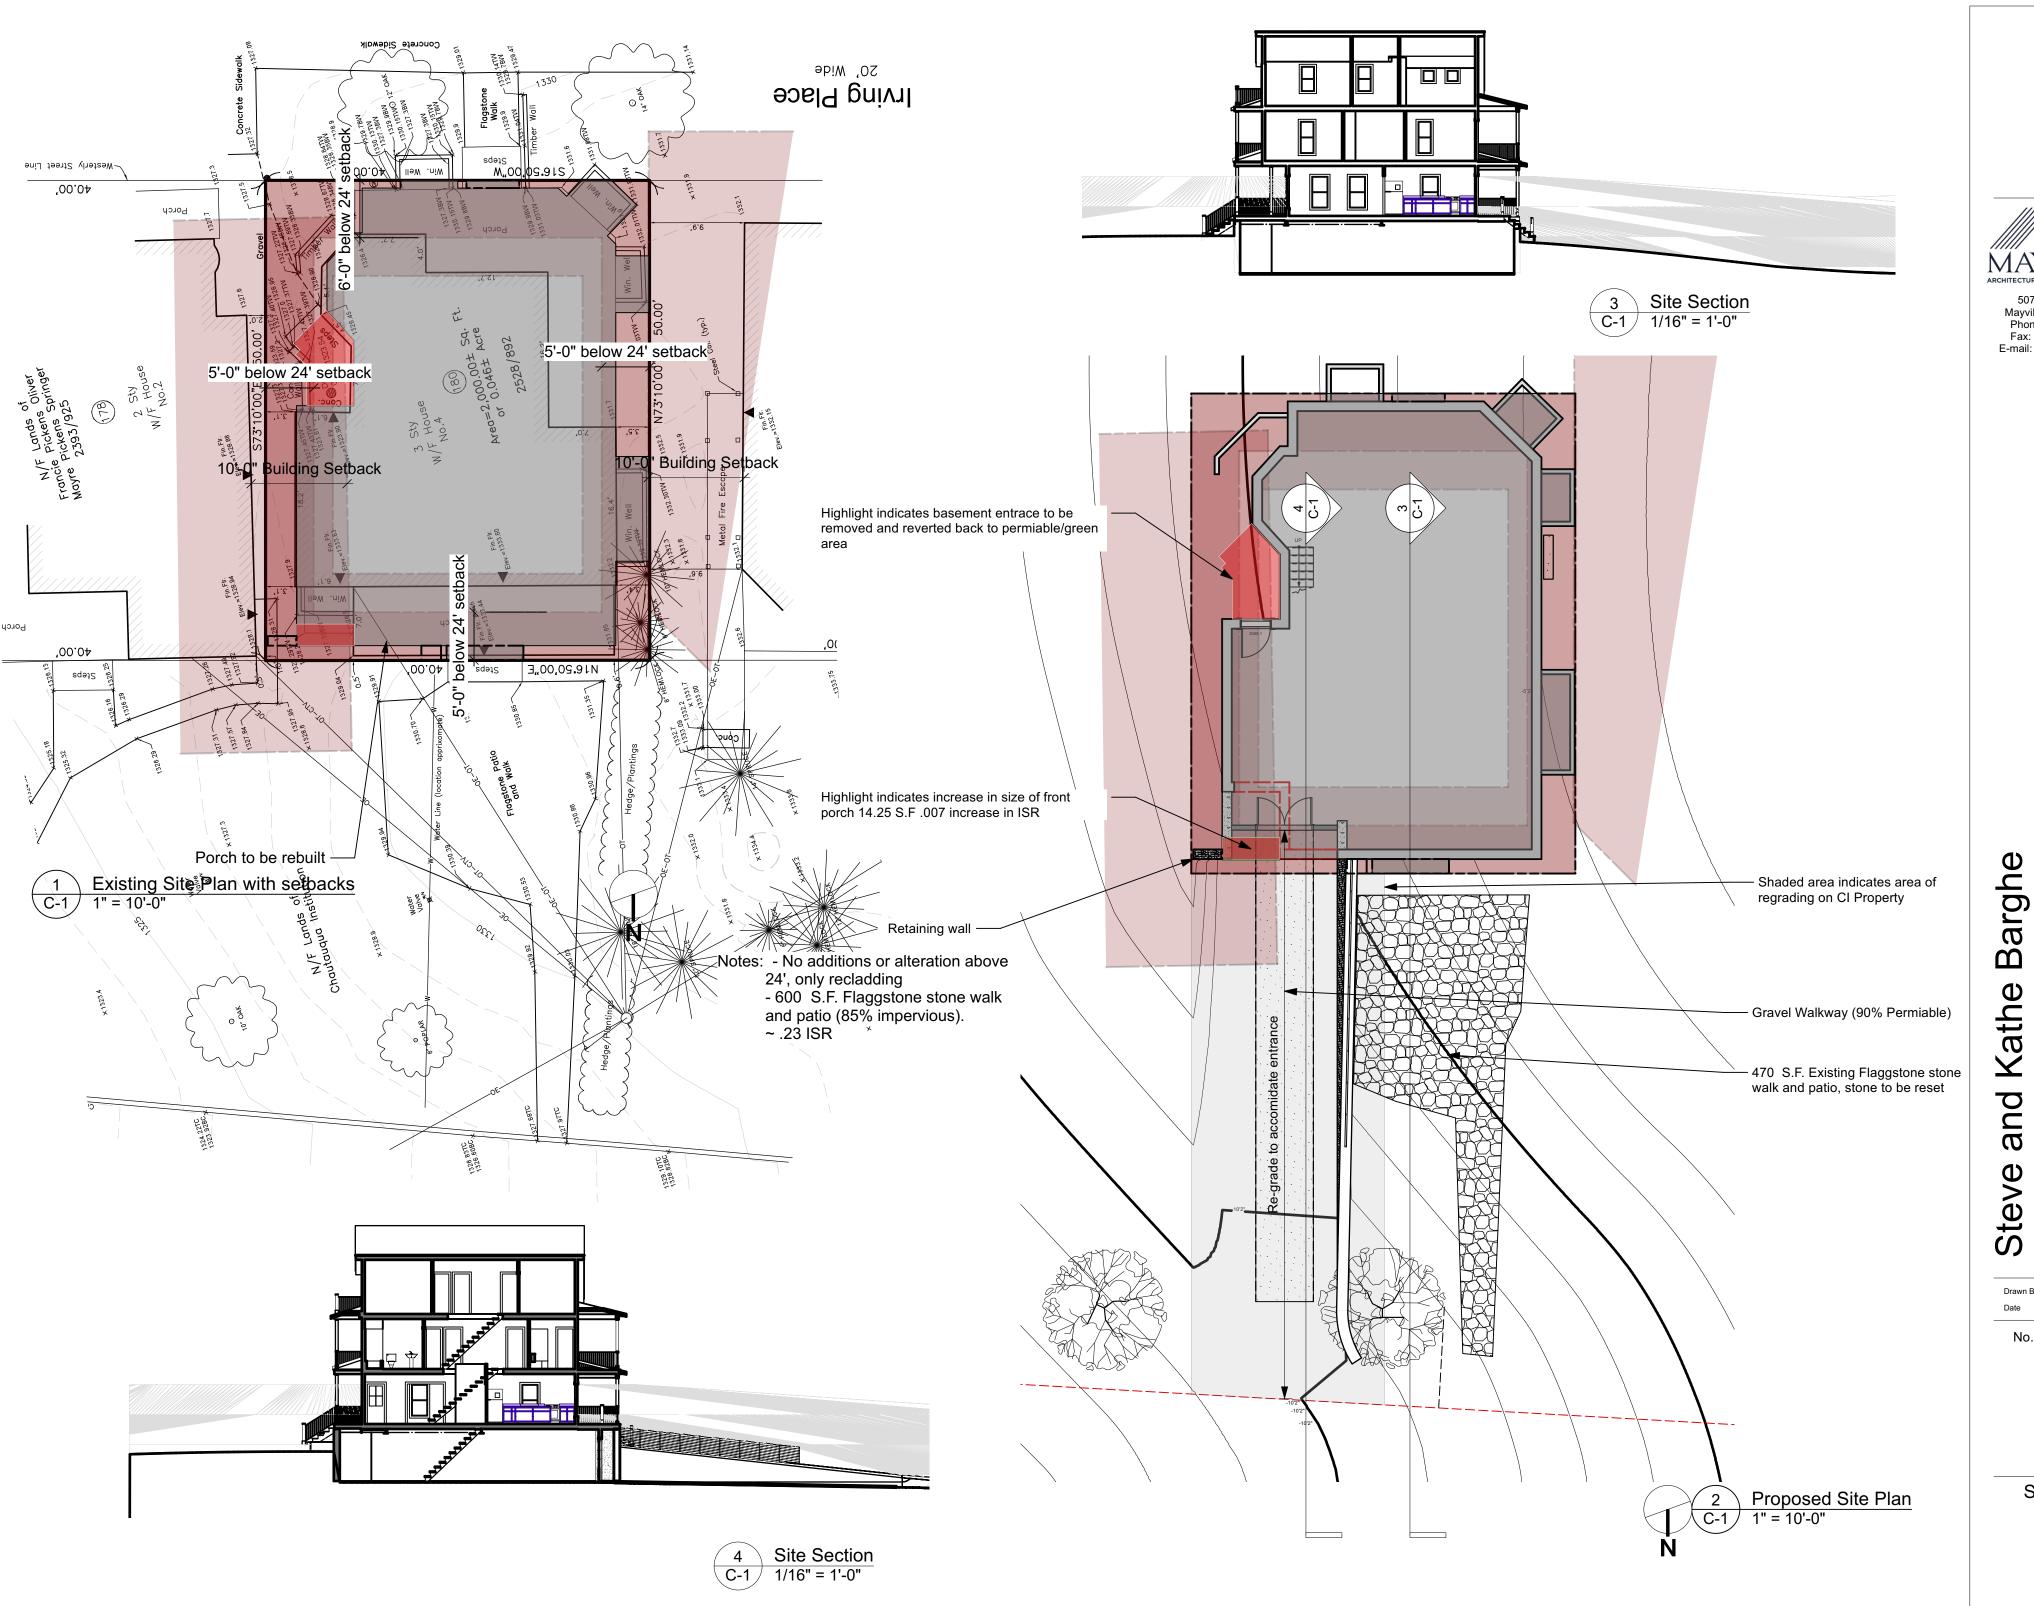



5073 West Lake Rd. Mayville, New York 14757 Phone: 716-386-6228 Fax: 716-386-4159 E-mail: mbi@mayshark.com

Steve and Kathe Barghe
4 Irving Place


Chautauqua NY 14722


Drawn By MBI
Date 03.24.2022

No. Date

Site Plans

C-1

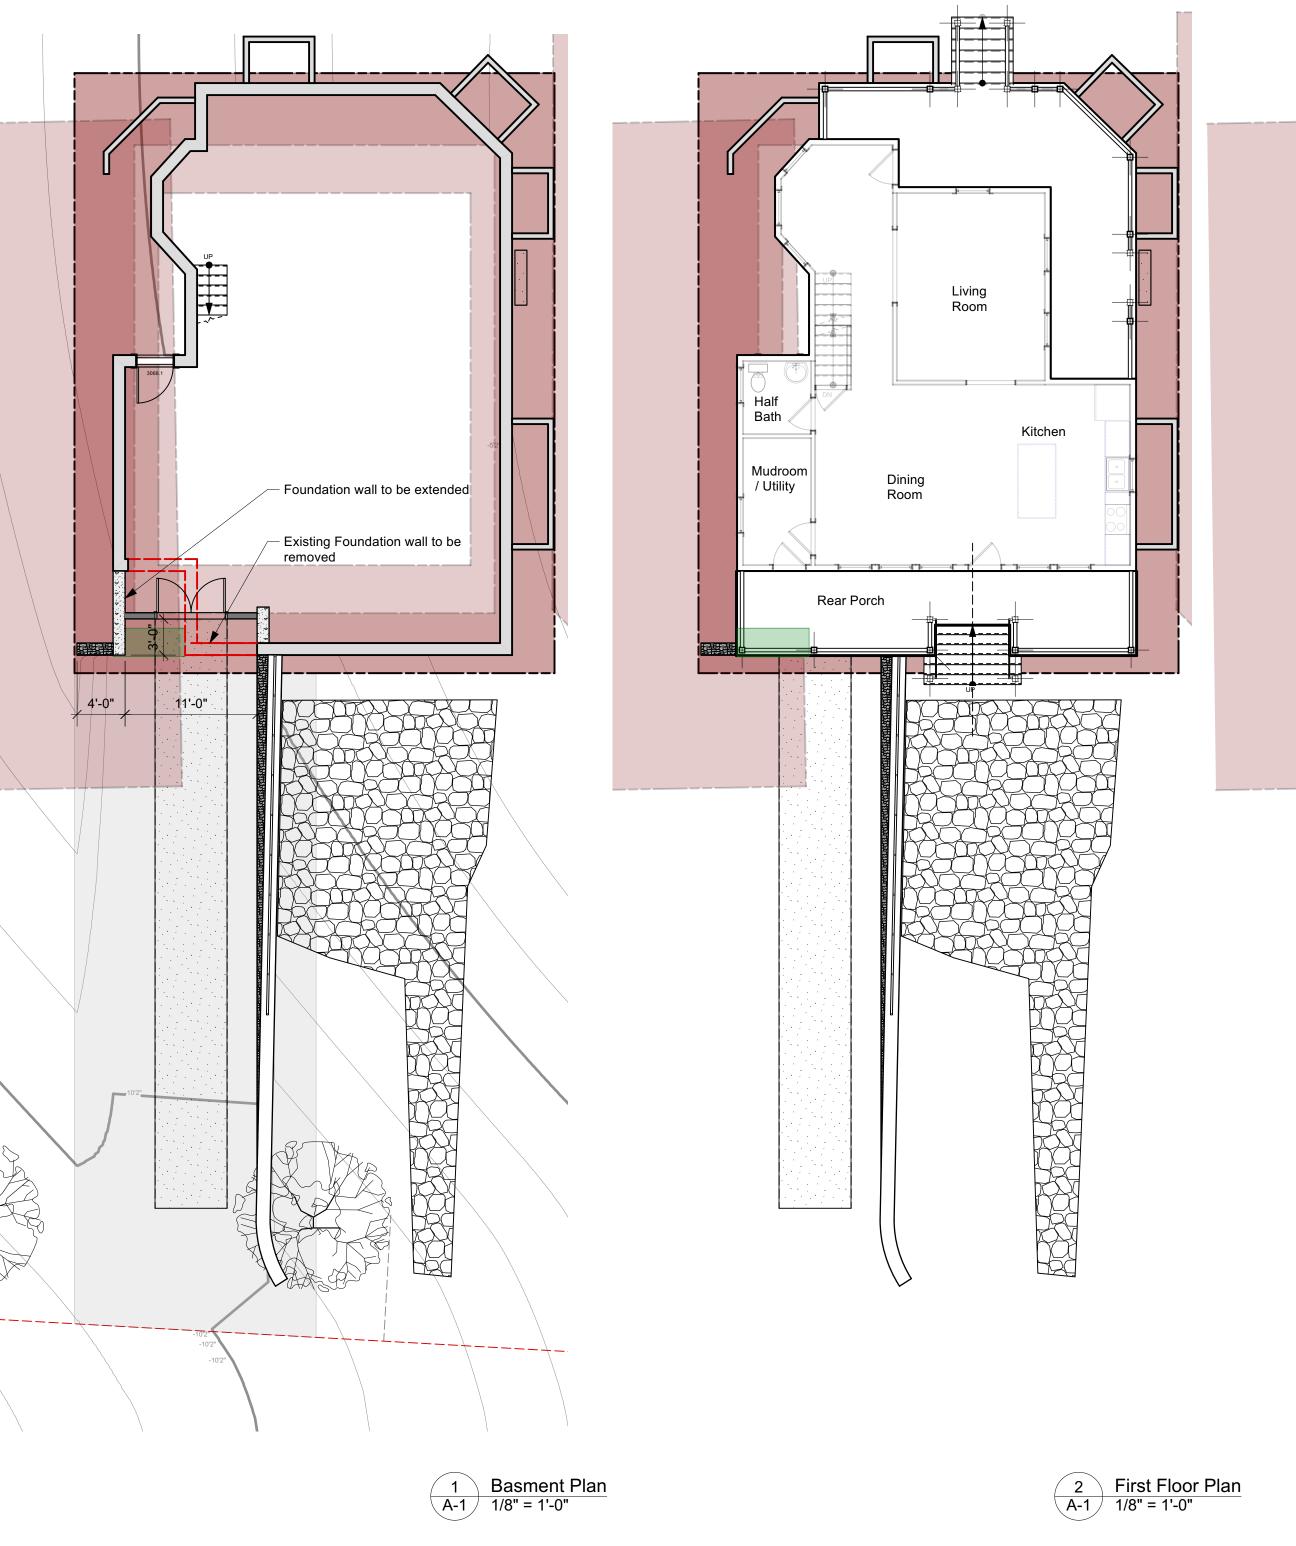

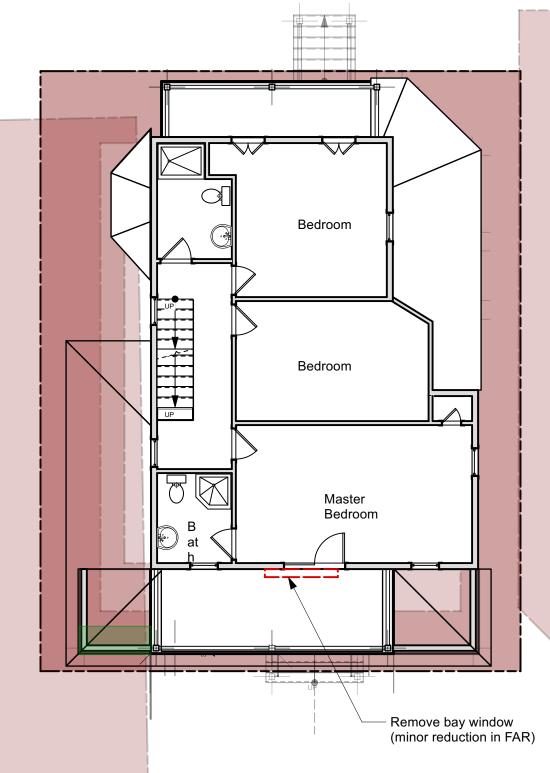

3 Second Floor Plan A-1 1/8" = 1'-0"

4 Irving Place

Impervious Surface Ratio (ISR) – Worksheet

Existing or Proposed	Proposed		
Site Address	4 Irving	Place	
Total Lot Area	2000 s	quare feet	
Impervious Surfaces:			
Total building footprint	1408 st	f X 100 <u>% =</u>	1408
Total porches, decks, stairs, steps	16_sf	X 100 <u>% =</u>	16
Total concrete or asphalt walks & drives	0_sf	X 100 <u>% =</u>	
Total gravel walks & drives	0_sf	X 90 <u>% =</u>	
Total crushed or washed stone walks & drives	9_sf	X 10 <u>% =</u>	9
Total brick, pavers or flagstone set in min. sand or gravel base	0_sf	X 90% =	
Total brick, pavers or flagstone set in permeable bed	0_sf	X 10% =	
Retaining wall/ Window wells	6/130 s	f X <u>% =</u>	6/130
Total Impervious Surface Area:			1561
1561	1	2000 =	78%
Total Impervious Surface Area	divided by T	otal Lot <u>Area =</u>	ISR

Note: Building footprint is the basement area which has porches above




Steve and Kathe
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Floor Plans

A-1



Notes: - Existing facia, soffits and trims to

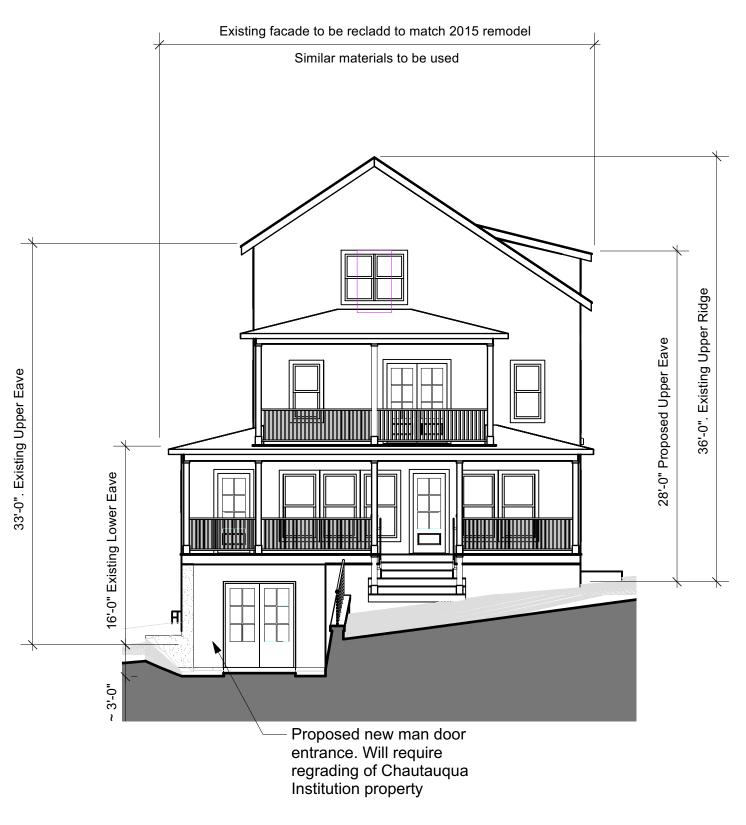- Rear Elevation
 Scale: 1/8" = 1'-0"
- East Elevation not drawn to be recladd in its entirety

be maintained and repaired

- West Elevation not drawn to be recladd in its entirety
- This should complete the project started in 2015



3 Existing construction (Streetscape)
A-2 NTS

Barge Variance request 03.22.2021

4.4.3 ISR is existing not conforming

 we are proposing to remove impervious surface equal to what is being added

4.4.6 Building Setbacks

- Rear yard setback not specified below 24' is 5'-0"
 - we are proposing to improve and existing non conforming porch, by altering the second story to allow for a sloped roof structure and a smaller occupiable porch
 - Please note a similar project was approved in 2015 allowing for a full second story porch our current request is for partial.
- Less than 10'-0" from neighboring structure
 - Approximately 14.25 sq.ft. is being requested to be added to the existing first floor porch, to simplify construction over the Basement French door entrance
- Rear Yard
 - We are Proposing to add a covered porch 20'x7' on the second floor. The remainder of the first floor porch will covered by a roof.

6.11.2 Demolition.

- The original roof porch construction was not built to adequately shed water, the flashings on the roof were improperly installed or omitted. The only technically feasible approach included demolition of the porch roof structure to inspect for deteriorated structural elements and to reconstruct using proper flashings and roofing
- The original porch deck construction was not constructed to include a
 basement underneath of it and adequate water proofing was not installed
 when the house was lifted and the basement was installed under it. The
 only technically feasible approach includes demolition of the porch deck
 structure and reconstruction using proper waterproofing membrane and
 flashings.
- Please note a similar project at this address was approved in 2015 allowing for a reconstruction of the existing porch and an addition of second story porch our current request is for partial.

Chautauqua Institution Property Impervious Surface Ratio (ISR) – Worksheet

Existing or Proposed	Propos	ed		
Site Address	4 Irving Place			
Total Lot Area	2213 square feet			
Impervious Surfaces:				
Total building footprint	o	f X 100 <u>% =</u>	0	
Total porches, decks, stairs, steps	17_st	X 100 <u>% =</u>	17_s	
Total concrete or asphalt walks & drives	0_sf	X 100 <u>% =</u>	0_s	
Total gravel walks & drives	0_st	X 90 <u>% =</u>	0_s	
Total crushed or washed stone walks & drives	294st	X 10 <u>% =</u>	_29.4_s	
Total brick, pavers or flagstone set in min. sand or gravel base	0_sf	X 90% =	0_s	
Total brick, pavers or flagstone set in permeable bed	470_ _{sf}	X 10% =	47_s	
Other Retaining wall	_856_s	f X <u>%=</u>	75_s	
Total Impervious Surface Area:			168	
168	,	2213	7.6%	
Total Impervious Surface Area	divided by	Total Lot <u>Area =</u>	ISR	



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Steve and Kathe Barghe 4 Irving Place

hautauqua NY

Drawn By MBI
Date 03.24.2022

No. Date

Elevations

A-2