

#### OFFICE OF CAMPUS PLANNING & OPERATIONS

March 24<sup>th</sup> 2023

#### ARCHITECTURAL REVIEW BOARD MEETING NOTIFICATION

Dear Chautauquan,

The owners of 4 Vincent Avenue, Terry Walkerly and Kris Putnam-Walkerly, in the Mixed Use Core District, are coming before the Architectural Review Board with plans proposing a restoration of their home. The proposed scope of work including the replacement of substandard foundations and porches as they wrap around the house, as well as a substantial restoration of the Building itself to bring it back to a historic single family home from its current use as multifamily residences. This project's scope of work includes variances for the proposed work on the porches with encroachments on the northern, eastern, and southern sides of the Building, a variance for proposed work within 10" of a neighboring Building, as well as a request for a license to encroach with a new deck onto Chautauqua property on the southern side of the property, and a request to remove the existing 24" maple located on adjacent Chautauqua Institution property. Therefore, this project requires an Architectural Review Board review for the following considerations required for the proposed scope of work.

#### Variances/Requests being considered:

- 1) Request to improve porches with an existing encroachment over the N/E property line along North Terrace Avenue (ALU 6.3)
- 2) Request to improve porches with an existing encroachment over the S/E property line facing Vincent Avenue (ALU 6.3)
- 3) Variance for construction within 10'-0" of a neighboring Building (ALU 4.3.6)
- 4) Variance to exceed the maximum Floor Area Ratio for the Mixed Use Core District of 1.37 by reducing the FAR of the Building from 2.27 to 2.19 (ALU 4.3.3)
- 5) Request for a license to encroach onto Chautauqua Institution with a proposed deck on the S/E side of the property facing Vincent Avenue (ALU 5.14.6)
- 6) Variance to exceed the maximum impervious surface area ratio (.25 for corner lots) for property owned by Chautauqua Institution to connect a property to the street (ALU 5.8.3.2)
- 7) Request for the removal of the existing 24" maple from the adjacent Chautauqua Institution property along Vincent Avenue (ALU 5.13.7)
- 8) Variance to exceed the maximum height of 24" for a retaining wall to contain the slope on-site (ALU 5.7.3.8)

You are receiving this notification because your property is approximately within 150' of the proposed project site. Plans for this project may be reviewed online using the following link:

#### Architecture Review Board (ARB) News and Notes - Chautauqua Institution (chq.org)

The Architectural Review Board will meet on May 4<sup>th</sup> 2023 at the Turner Community Center, conference room, at 12:00pm noon. See instructions for attending this conference below. Please submit any comments that you may have in writing for the Architectural Review Board's consideration. E-mails are preferred and may be submitted to the administrator of architectural and land use regulations at arb@chq.org until 12:00 noon on May 3<sup>rd</sup> 2023.

Thank you for your time,


Ryan B. Boughton, Assoc. AIA

Administrator of Architectural and Land Use Regulations

rboughton@chq.org | o: 716.357.6245

# **OPTION "A"**



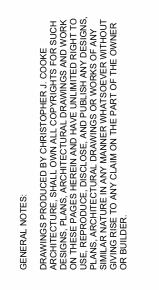


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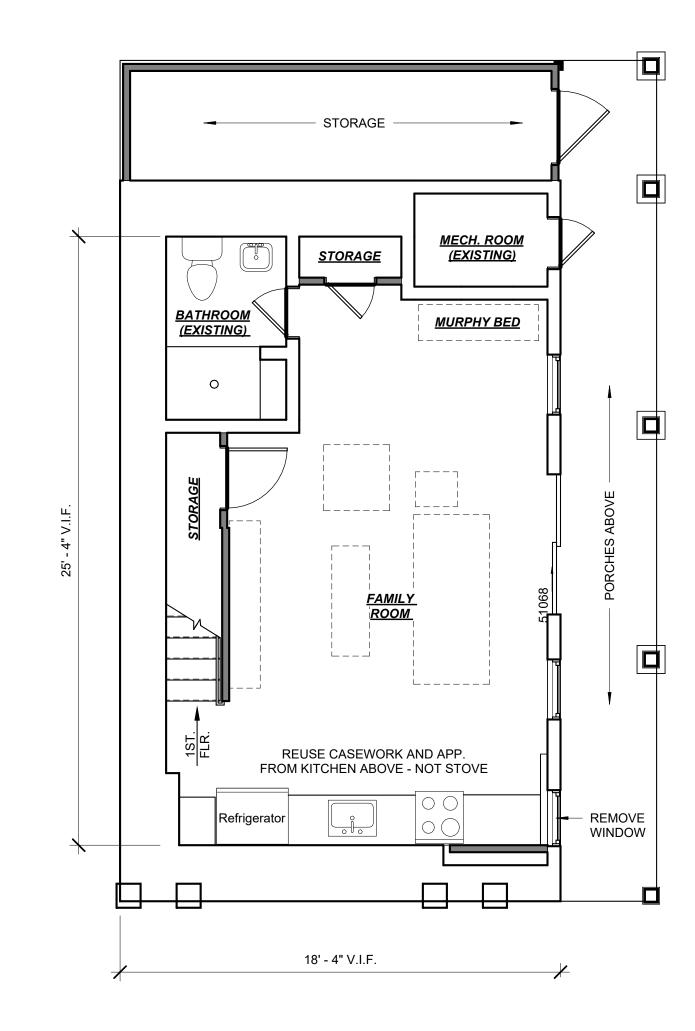


WALKERLY RESIDENCE

SCALE: 1/4" = 1'-0"


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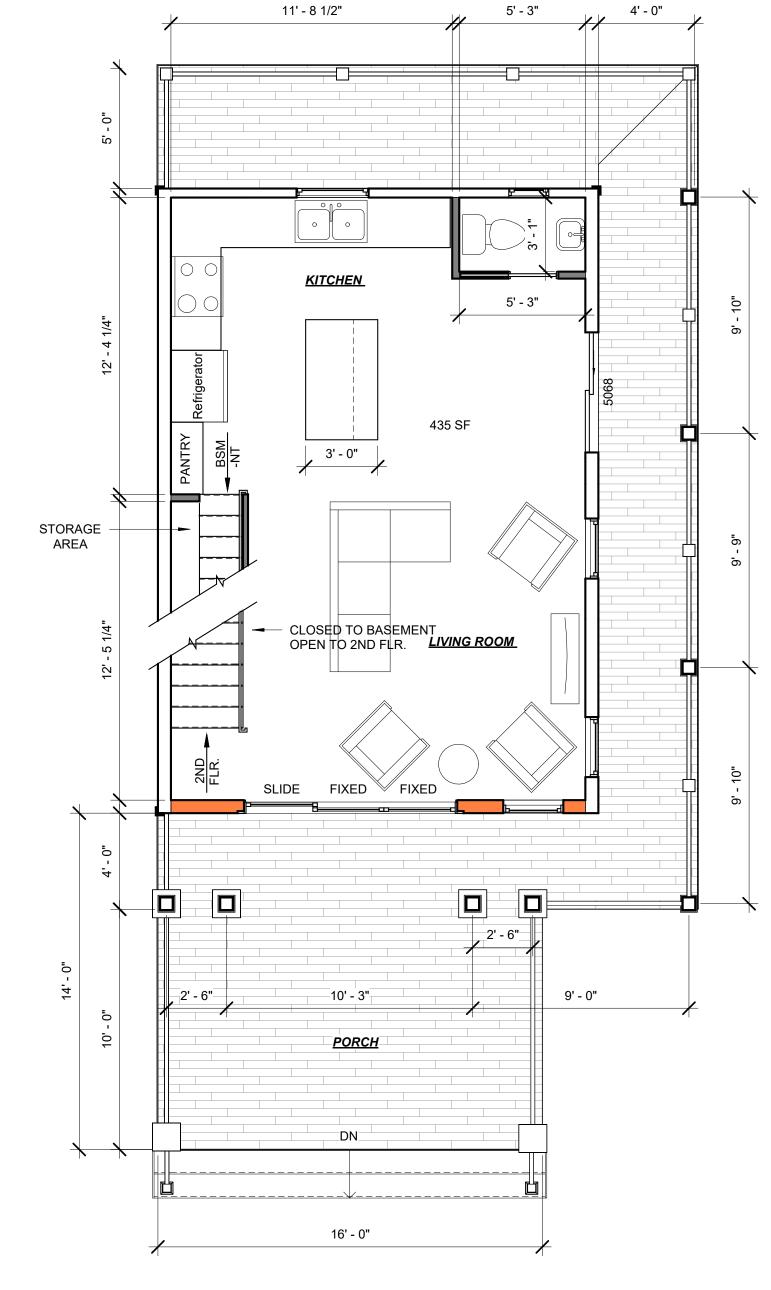


BASEMENT (PROPOSED)

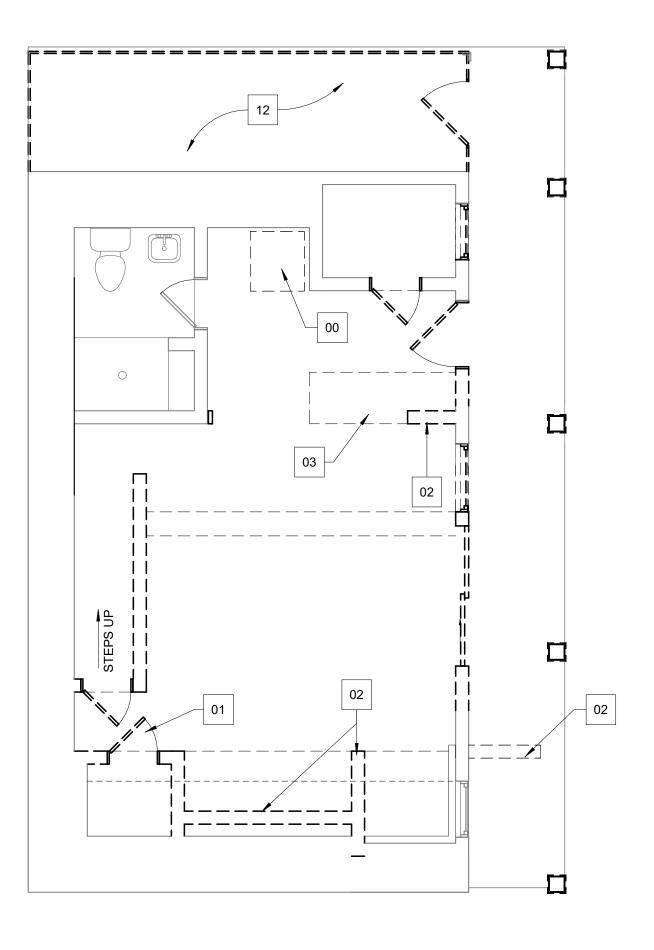1/4" = 1'-0"





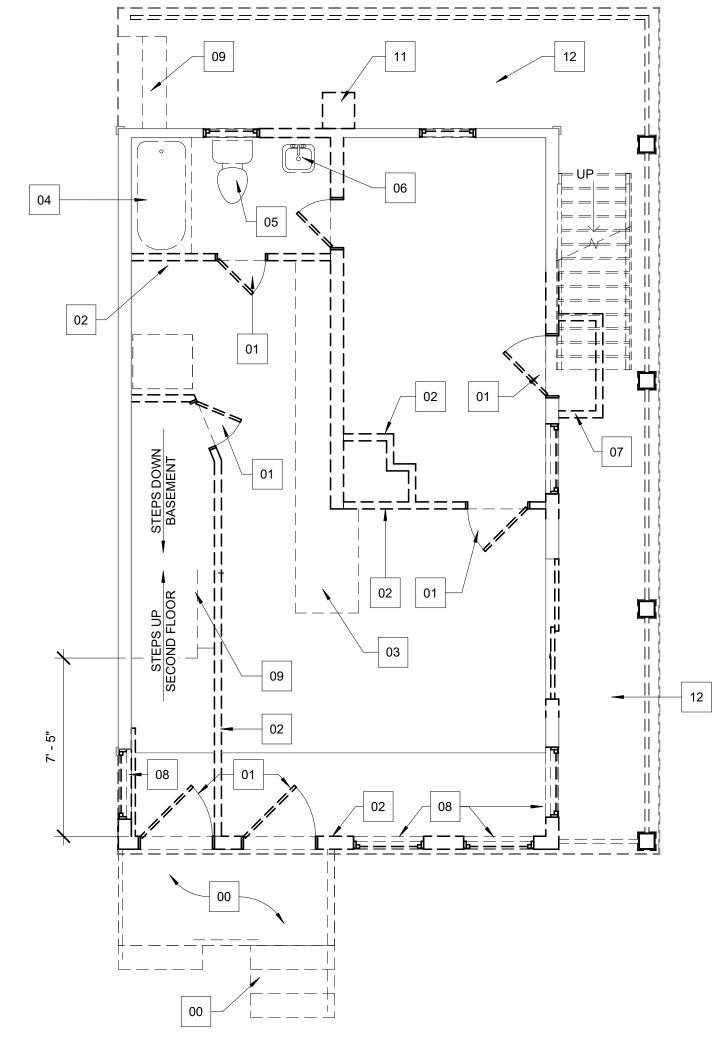

1 FIRST FLOOR (PROPOSED)
1/4" = 1'-0"

# **BASEMENT (DEMO PLAN)**1/4" = 1'-0"

- EXISTING DOOR(S) TO BE REMOVED.
- EXISTING WALL(S) TO BE REMOVED
- EXISTING KITCHEN COUNTER(S), FIXTURE(S), CASEWORK, AND APPLIANCE(S) TO BE REMOVED
- EXISTING SHOWER/TUB TO BE REMOVED
- EXISTING TOILET(S) TO BE REMOVED
- EXISTING SINK/VANTY TO BE REMOVED
- EXISTING CLOSET TO BE REMOVED
- EXISTING WINDOW(S) TO BE REMOVED
- EXISTING STAIR(S) TO BE REMOVED
- EXISTING EXTERIOR STORAGE TO BE REMOVED
- EXISTING CHIMNEY TO BE REMOVED
- EXISTING PORCHES TO RECONSTRUCTED (FLOORS, CEILINGS, COLUMNSS, RAILS)

## **DEMOLITION NOTES**


**1 1/2" = 1'-0"** 





SCALE: As indicated


DATE: 03-22-23 DRAWN BY: CC OJECT NUMBER: 22-116

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# SECOND FLOOR (DEMO PLAN) 1/4" = 1'-0"

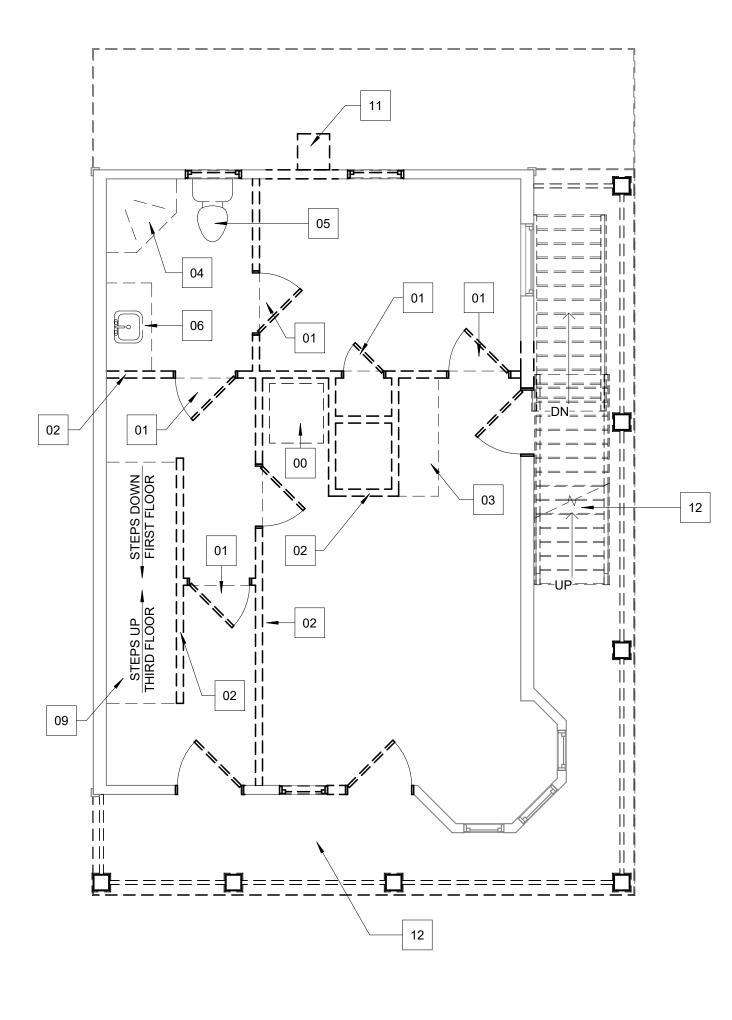SECOND FLOOR (PROPOSED)

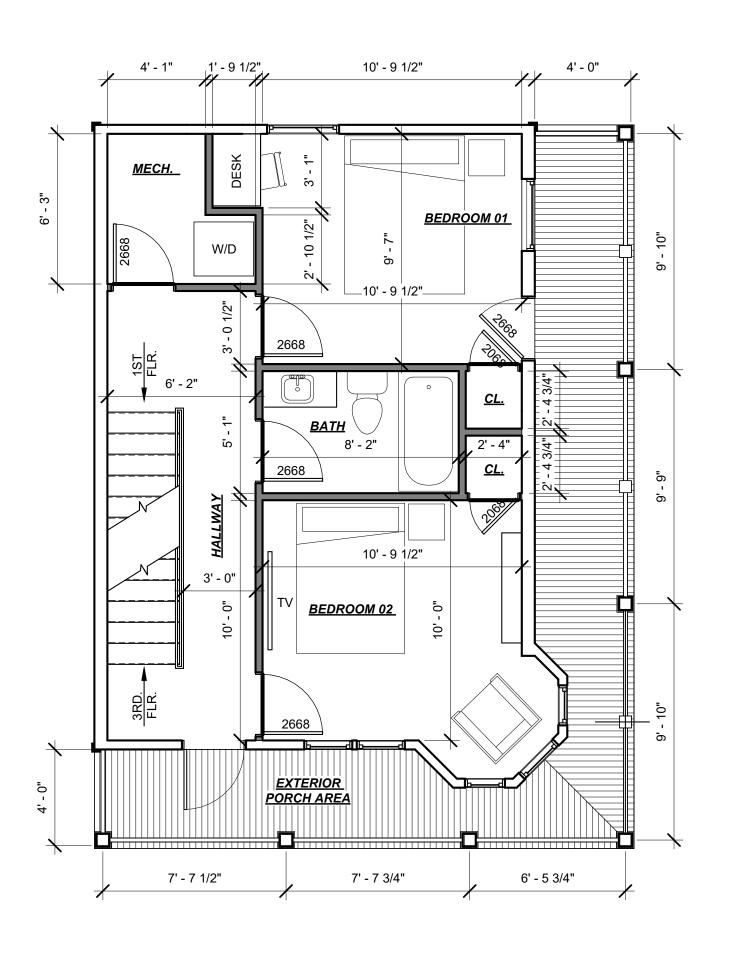1/4" = 1'-0"

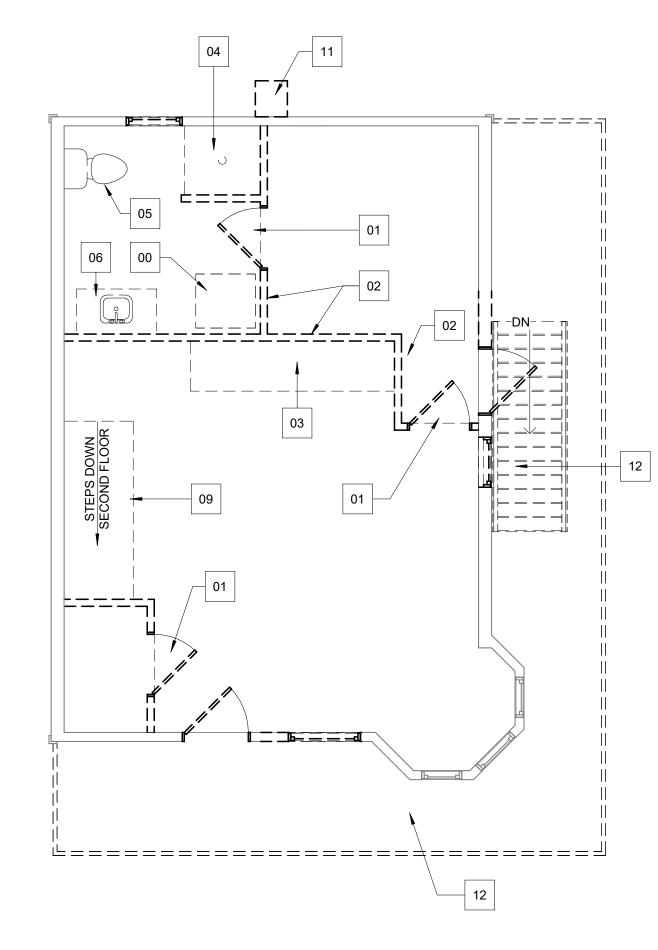THIRD FLOOR (DEMO PLAN)

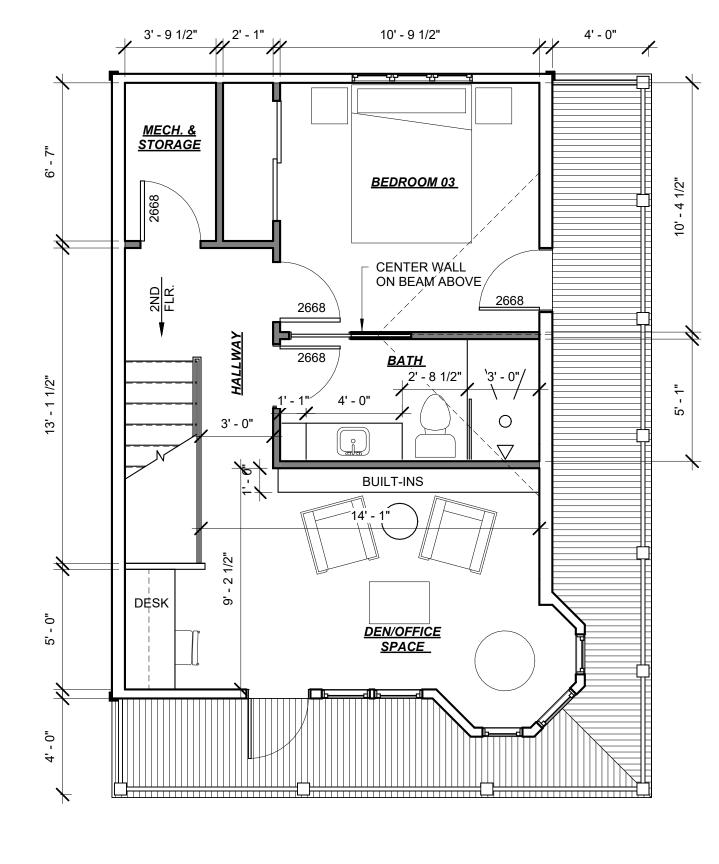1/4" = 1'-0"

THIRD FLOOR (PROPOSED)

1/4" = 1'-0"

01	EXISTING DOOR(S) TO BE REMOVED.	
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02 EXISTING WALL(S) TO BE REMOVED

03 EXISTING KITCHEN COUNTER(S), FIXTURE(S), CASEWORK, AND APPLIANCE(S) TO BE REMOVED

04 EXISTING SHOWER/TUB TO BE REMOVED

05 EXISTING TOILET(S) TO BE REMOVED

EXISTING SINK/VANTY TO BE REMOVED

07 EXISTING CLOSET TO BE REMOVED

08 EXISTING WINDOW(S) TO BE REMOVED

09 EXISTING STAIR(S) TO BE REMOVED

11 EXISTING CHIMNEY TO BE REMOVED

12 EXISTING PORCHES TO RECONSTRUCTED (FLOORS, CEILINGS, COLUMNSS, RAILS)

## **DEMOLITION NOTES**

EXISTING EXTERIOR STORAGE TO BE REMOVED

5 1 1/2" = 1'-0"

GENERAL NOTES:

DRAWINGS PRODUCED BY CHRISTOPHER J. COOKE
ARCHITECTURE, SHALL OWN ALL COPYRIGHTS FOR SUCH
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GIVING RISE TO ANY CLAIM ON THE PART OF THE OWNER
OR BUILDER.

CHRIS COOKE

A R C H I T E C T U R E

Christopher J. Cooke Architecture, P.C.

chris@cjcarchitecture.com 716-228-0520
80 Maple Avenue - Cassadaga, New York 14718

ALKERLY RESIDENCE

4 VINCENT AVENUE
CHAUTAUQUA INSTITUTION

ON REVISION PR DATE


SCALE: As indicated

DATE: 03-22-23

DRAWN BY: CC

ROJECT NUMBER: 22-116


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NORTH TERRACE AVENUE SIDE ELEVATION - EXISTING

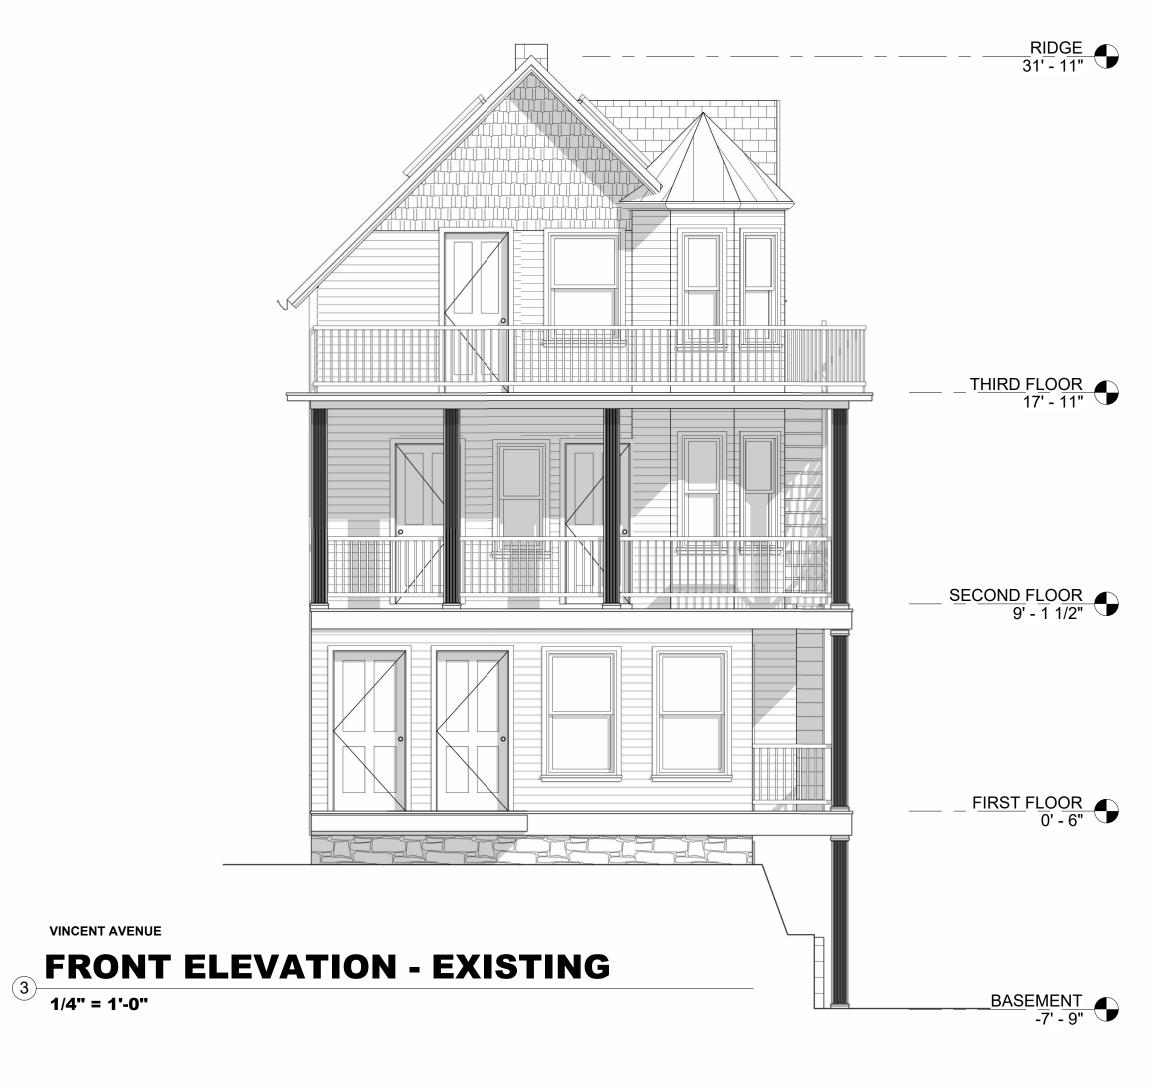1/4" = 1'-0"





**SIDE ELEVATION - PROPOSED** 

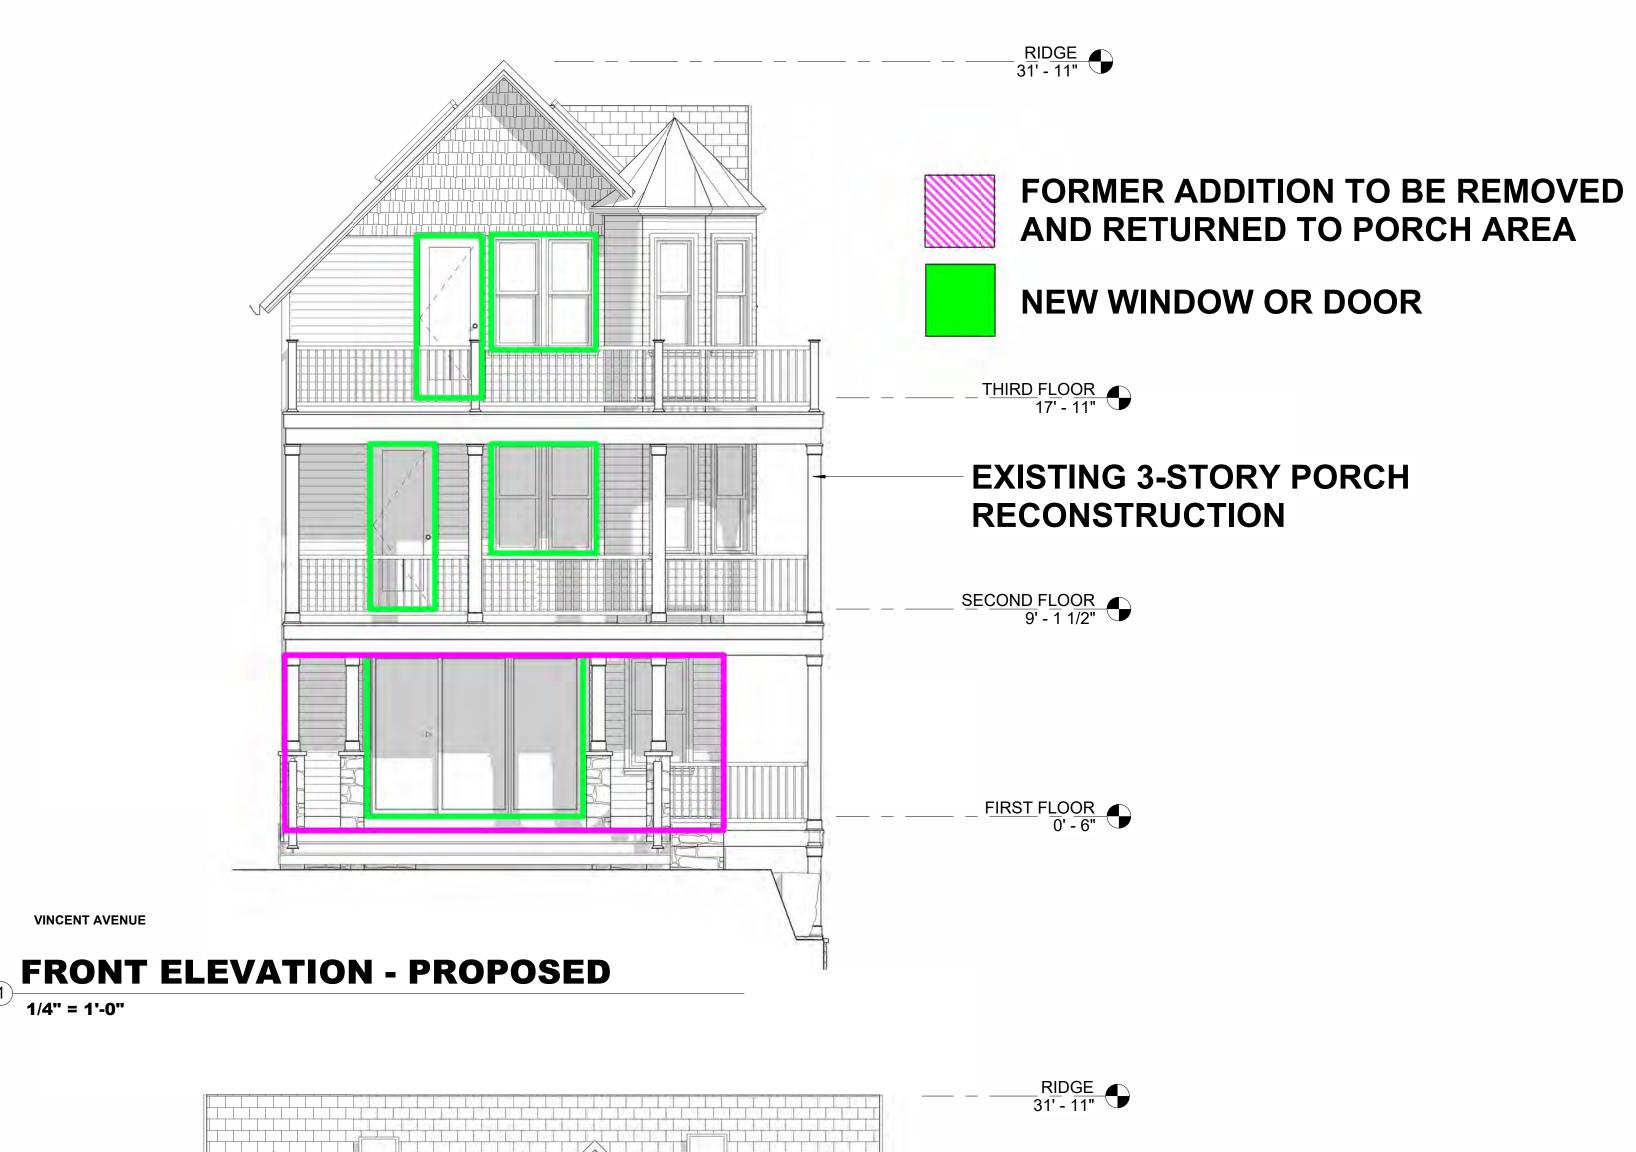






SCALE: 1/4" = 1'-0"


DATE: 03-22-23

SHEET NUMBER

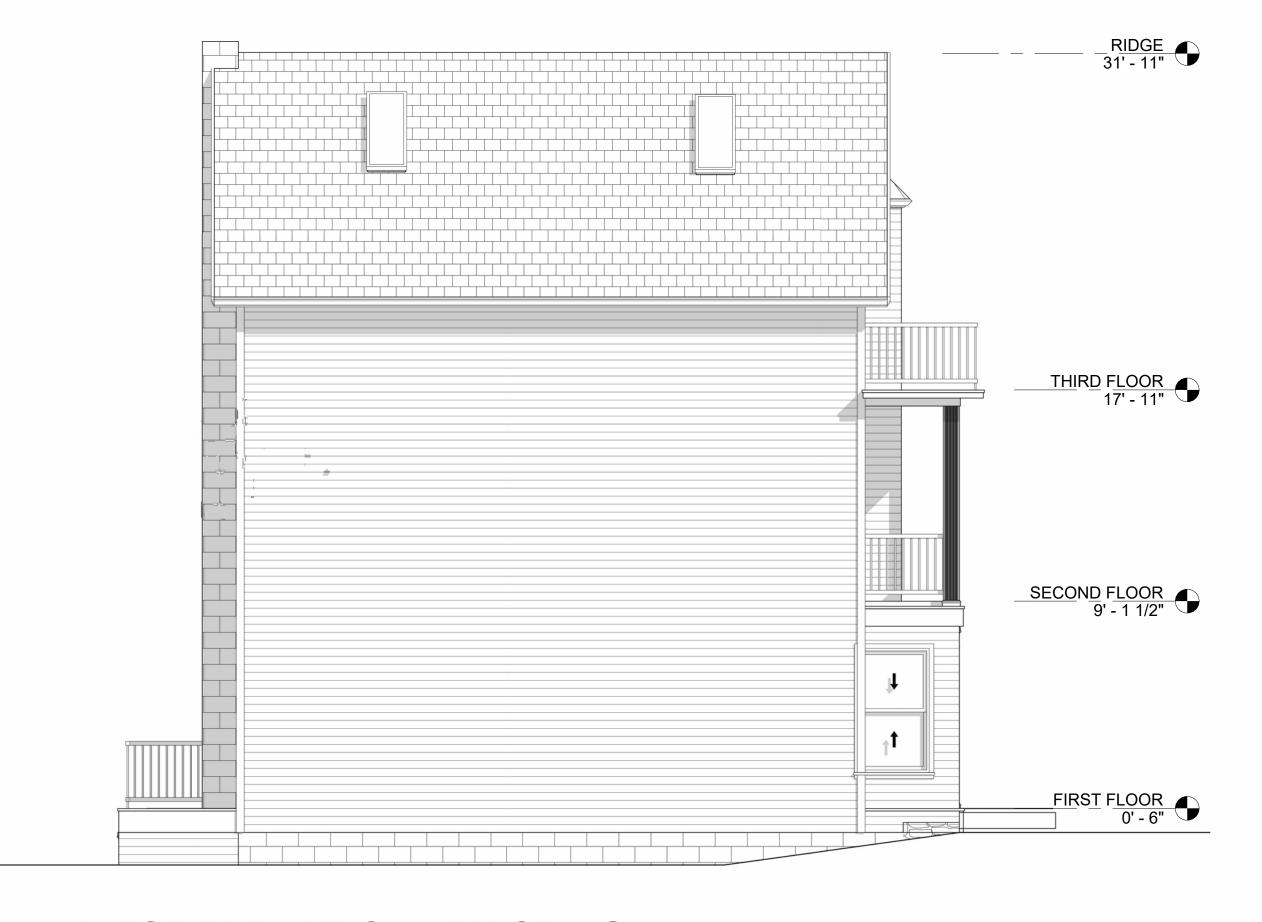




# WEST ELEVATION - EXISTING

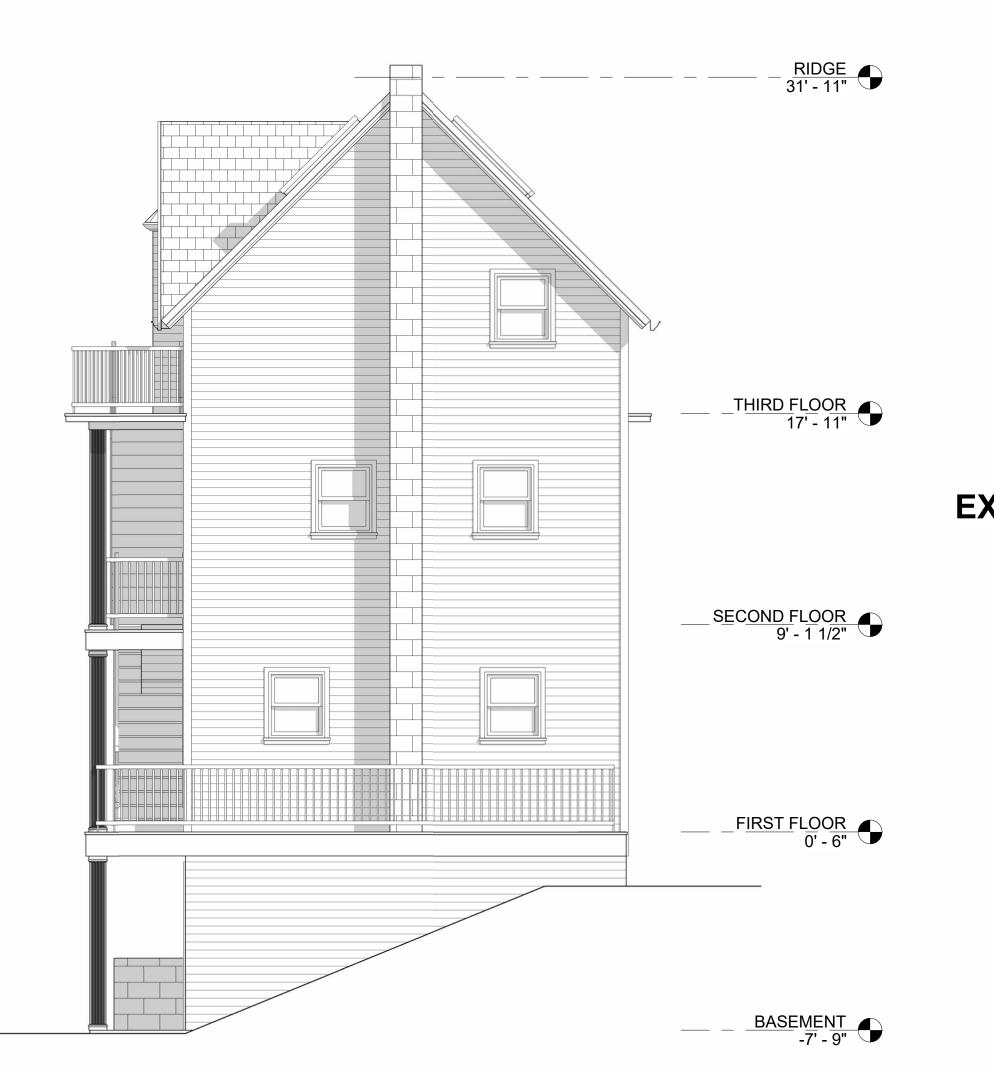

REAR ELEVATION - EXISTING

1/4" = 1'-0"

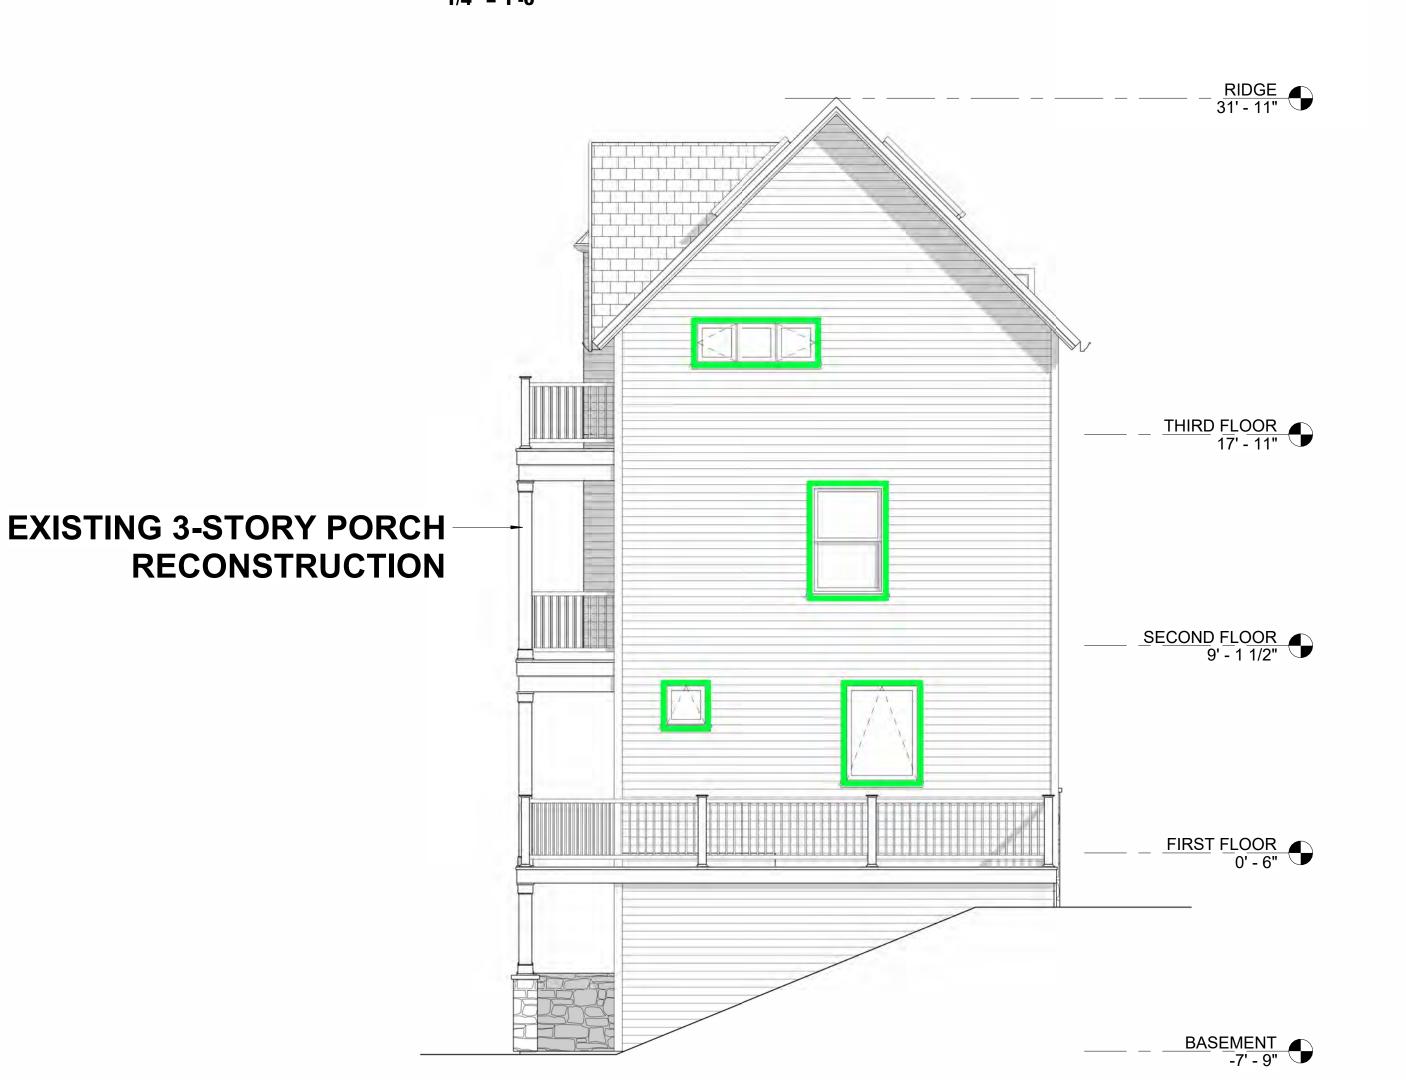

**WEST ELEVATION - PROPOSED** 

## REAR ELEVATION - PROPOSED

1/4" = 1'-0"







WALKERLY RESIDENCE

4 VINCENT AVENUE
CHAUTAUQUA INSTITUTION
CHAUTAUQUA, NEW YORK 14722

N REVISION DATE

SCALE: 1/4" = 1'-0"

DATE: 03-22-23

RAWN BY: CC

NUMBER: 22-116

SHEET NUMBER:



# PUTNAM-WALKERLY RESIDENCE

4 VINCENT AVENUE CHAUTAUQUA, NEW YORK COUNTY OF CHAUTAUQUA LANDSCAPE ARCHITECT: LEAF+STONE LANDSCAPE ARCHITECTURE 5363 DEAN ROAD STOCKTON, NEW YORK, 14784 (716) 952 4666

ARCHITECT:
CHRIS COOKE ARCHITECTURE
25 SOUTH MAIN STREET
CASSADAGA, NEW YORK, 14718
(716) 228 0520


CLIENT:


KRIS PUTNAM-WALKERLY & TERRY WALKERLY 4 VINCENT AVE. CHAUTAUQUA, NEW YORK, 14712 DRAWING INDEX:


L 0.0 EXISTING CONDITION SITE PLAN L.01 EXISTING ISR TABULATION L 1.0 DEMOLITION & TEMP. EROSION AND SEDIMENT CONTROL PLAN L 2.0 PROPOSED SITE PLAN L2.1 PROPOSED SITE SURFACE TREATMENT GROUND FIGURE L3.0 SITE DETAILS - STONE BLOCK TERRACE WALL & STONE PAVING SLAB L3.1 SITE DETIALS - PERMEABLE AGGREGATE HARDSCAPE W/ REINFORCING GRID L4.0 ALTERNATE SITE PLAN CONCEPT L4.1 ALTERNATE SITE SURFACE TREATMENT GROUND FIGURE

ISSUE DATE:

March 21, 2023 SEAL:

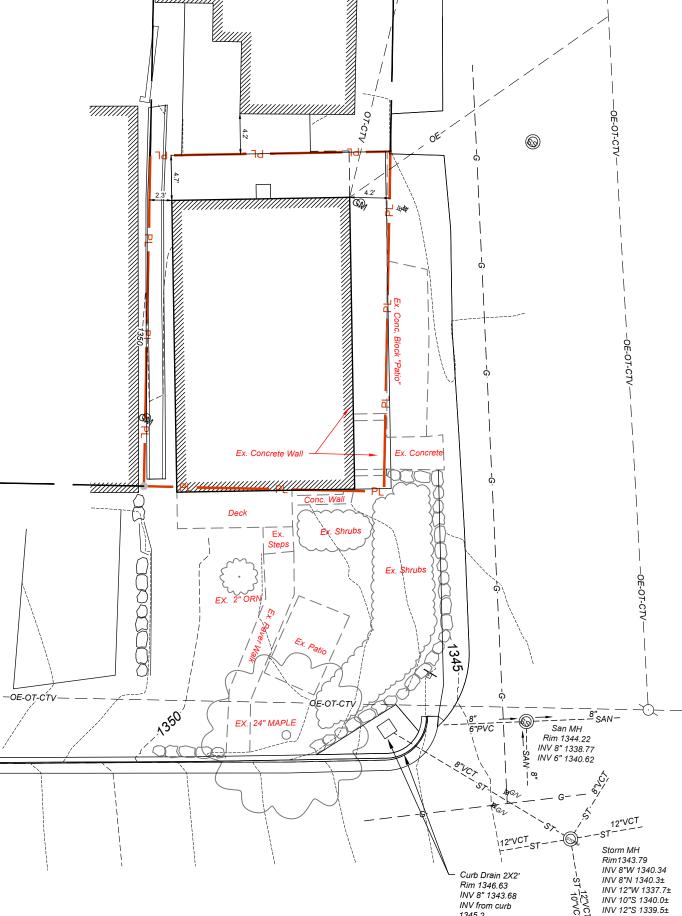

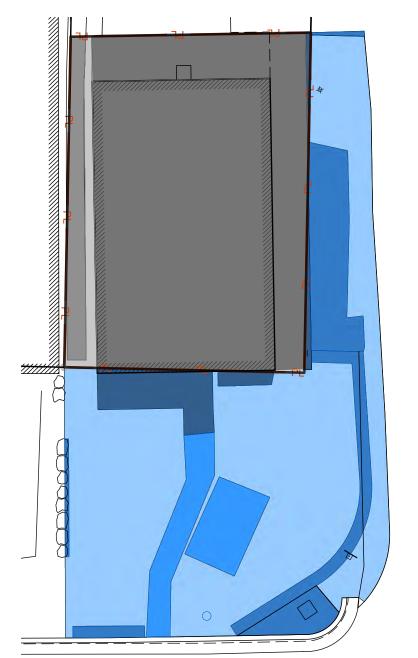

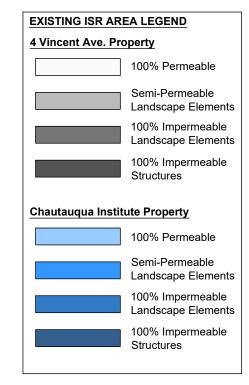

## Existing ISR Areas Site Plan

Scale: 1" = 10'-0"

#### **GENERAL NOTES:**

- 1. SITE BASE MAP DEVELOPED EXISTING CONDITIONS AND TOPOGRAPHIC SITE SURVEY PREPARED BY RODGERS LAND SURVEYING DATED: 09/15/2022. CONTRACTOR SHALL CONTACT SURVEYOR FOR BENCHMARK INFORMATION AT (716) 665-2828.
- 2. EXISTING UTILITY LOCATIONS SHOWN ARE APPROXIMATE ONLY CONTRACTOR SHALL VERIFY LOCATIONS OF ALL UTILITIES ON SITE PRIOR TO BEGINNING EXCAVATION. ADDITIONAL UTILITIES MAY BE PRESENT IN ADDITION TO THOSE INDICATED IN THE PLAN SET.
- UNDERGROUND UTILITIES EXIST, CONTRACTOR SHALL BE RESPONSIBLE FOR CALLING 811DIG-SAFE FOR UTILITY MARK-OUT PRIOR TO THE COMMENCEMENT OF ANY WORK
- THE CONTRACTOR SHALL COORDINATE WITH UTILITY PROVIDERS FOR INSTALLATION AND CONNECTION OF UTILITIES

- INSTALLED PRIOR TO THE COMMENCEMENT OF ANY DEMOLITION OR EARTH-WORK ACTIVITIES AND SHALL BE MAINTAINED IN GOOD WORKING ORDER.
- EARTHWORK SHALL BE PERFORMED IN ACCORDANCE WITH REQUIREMENTS OUTLINED IN "NEW YORK STATE GUIDELINES FOR EROSION AND SEDIMENT CONTROL" AND AS INDICATED IN THE PROJECT SPECIFICATIONS
- TOPSOIL AND SEED ALL AREAS DISTURBED BY CONSTRUCTION ON THIS PROJECT NOT INDICATED AS STRUCTURE, PAVEMENT OR PLANTING BED
- COORDINATE WORK WITH OTHER TRADES.
- CONTRACTOR SHALL KEEP A CLEAN AND TIDY WORK SITE. TRASH AND LITTER TO BE PICKED -UP AND DISPOSED OF AT THE CLOSE OF EACH DAY.
- 10. THE CONTRACTOR SHALL KEEP THE PUBLIC ROADWAY CLEAR OF DEBRIS AND SHALL CLEAN TO REMOVE DIRT/DUST/MUD AT

\_eaf+Stone Landscape Architecture

5363 Dean Road Stockton, New York 14784 www.LeafandStone.design

716-952-4666

CLIENT:
KRIS & TERRIE WALKERLY
4 VINCENT AVENUE
CHAUTAUQUA, NY, 14712

**DATE:** March 21, 2023

RE-ISSUE: MM.DD.YYYY

PROJECT:
Site & Landscape Master F
4 Vincent Avenue
Chautauqua, New York

DRAWN BY: JWR, PLB

DRAWING TITLE: EXISTING CONDITIONS SITE PLAN



**Existing Conditions Site Plan** 

Scale: 1" = 10'-0"

INV 12"E 1337.7±

5. ALL TEMPORARY SEDIMENT AND EROSION CONTROLS SHALL BE

### 4 Vincent Ave - Existing Surface Treatment Tabulation

				P	RIVATE PROPER	RTY		СН	IAUTAUC	UA INSTITUTI / STREET R.O		RTY
CATEGORY		DESCRIPTION	ACTUAL AREA (SF)	Credit (%)	TABULATION (sf)	Sub-total (sf)	Percentage of lot	ACTUAL AREA (SF)	Credit (%)	TABULATION (sf)	Sub-total (sf)	Percentage of lot
TOTAL GREENSPACE						0	0%				800	68%
	100% PERMEABLE	All open / landscape areas void of structures or pavement elements.										
		Planting Beds	0.0	100%	0.0			800.0	100%	0.0		
		Lawn	0.0	100%	0.0			0.0	100%	0.0		
TOTAL IMPERVIOUS:						863	100%				354	30%
	STRUCTURES	Includes covered porches, window wells				772					78	
		Building w/ attached covered porch(s)	772.0	0%	772.0			78.0	0%	78.0		
	IMPERMEABLE LANDSCAPE ELEMENTS	Includes garden walls, impermeable patios, sidewalks, driveways, etc.				92					184	
		Slab-on-grade Concrete	91.5	0%	91.5			120.0	0%	120.0	9	
		Retaining Wall & Steps	0.0	0%	0.0			64.0	0%	64.0		
		Asphalt Pavement	0.0	0%	0.0			0.0	0%	0.0		
	SEMI-PERMEABLE HARDSCAPE ELEMENTS	Includes permeable hardscape elements such as sidewalks, patios, driveways, wood-framed decks.				0					92	
		Exist. Semi Permeable Hardscape	0.0	15%	0.0			108.0	15%	91.8		
TOTAL SF OF PARCEL:			863,5					1,170.0				

5363 Dean Road Stockton, New York 14784 www.LeafandStone.design

716-952-4666

CLIENT: KRIS & TERRIE WALKERLY 4 VINCENT AVENUE CHAUTAUQUA, NY, 14712

**DATE:** March 21, 2023

RE-ISSUE: MM.DD.YYYY

PROJECT:
Site & Landscape Master Plan
4 Vincent Avenue
Chautauqua, New York

**DRAWN BY:** JWR, PLB

DRAWING TITLE: EXISTING CONDITIONS ISR TABULATION


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- SITE BASE MAP DEVELOPED EXISTING CONDITIONS AND TOPOGRAPHIC SITE SURVEY PREPARED BY RODGERS LAND SURVEYING DATED: 09/15/2022. CONTRACTOR SHALL CONTACT SURVEYOR FOR BENCHMARK INFORMATION AT (716) 665-2828.
- EXISTING UTILITY LOCATIONS SHOWN ARE APPROXIMATE ONLY. CONTRACTOR SHALL VERIFY LOCATIONS OF ALL UTILITIES ON SITE PRIOR TO BEGINNING EXCAVATION. ADDITIONAL UTILITIES MAY BE PRESENT IN ADDITION TO THOSE INDICATED IN THE PLAN SET.
- 3. UNDERGROUND UTILITIES EXIST, CONTRACTOR SHALL BE RESPONSIBLE FOR CALLING 811DIG-SAFE FOR UTILITY MARK-OUT PRIOR TO THE COMMENCEMENT OF ANY WORK.
- THE CONTRACTOR SHALL COORDINATE WITH UTILITY PROVIDERS FOR INSTALLATION AND CONNECTION OF UTILITIES WITH OTHER TRADES.

- . ALL TEMPORARY SEDIMENT AND EROSION CONTROLS SHALL BE INSTALLED PRIOR TO THE COMMENCEMENT OF ANY DEMOLITION OR EARTH-WORK ACTIVITIES AND SHALL BE MAINTAINED IN GOOD WORKING ORDER.
- 6. EARTHWORK SHALL BE PERFORMED IN ACCORDANCE WITH REQUIREMENTS OUTLINED IN "NEW YORK STATE GUIDELINES FOR EROSION AND SEDIMENT CONTROL" AND AS INDICATED IN THE PROJECT SPECIFICATIONS.
- TOPSOIL AND SEED ALL AREAS DISTURBED BY CONSTRUCTION ON THIS PROJECT NOT INDICATED AS STRUCTURE, PAVEMENT OR PLANTING BED.
- . COORDINATE WORK WITH OTHER TRADES.
- . CONTRACTOR SHALL KEEP A CLEAN AND TIDY WORK SITE. TRASH AND LITTER TO BE PICKED -UP AND DISPOSED OF AT THE CLOSE OF EACH DAY.
- 10. THE CONTRACTOR SHALL KEEP THE PUBLIC ROADWAY CLEAR OF DEBRIS AND SHALL CLEAN TO REMOVE DIRT/DUST/MUD AT THE END OF EACH WORK DAY.

#### **DEMOLITION NOTES**:

- PROVIDE, INSTALL AND MAINTAIN LINEAR SEDIMENT CONTROL(SILT FENCE OR COMPOST FILTER-SOCK) AS SHOWN AND AS DIRECTED BY LANDSCAPE ARCHITECT. CONTRACTOR SHALL REMOVE SEDIMENT FROM BACK-SIDE OF SILT FENCE WHEN SILT HAS ACCUMULATED TO 30% OF THE FABRIC HEIGHT OR AS DIRECTED.
- 2. THE CONTRACTOR SHALL INSTALL AND MAINTAIN IN-LET PROTECTION AS NEEDED OR DIRECTED
- 3. REMOVE EXISTING TREE. WORK SHALL BE PERFORMED BY A CERTIFIED AND INSURED ARBORIST. GRIND/ GRUB AND REMOVE STUMP AND ROOTS ENTIRELY. PROPERTY OWNER TO PROVIDE FOR THE INSTALLATION AND MAINTENANCE OF A REPLACEMENT TREE AT A ALTERNATE LOCATION ON CHAUTAUQUA INSTITUTION PROPERTY AS DESCRIBED IN THE ARCITECTURE AND LAND-USE REGULATIONS.
- 4. THE CONTRACTOR SHALL COORDINATE FOR REMOVAL OF EXISTING SHRUBS. ALL STUMPS AND ROOTS SHALL BE GRUBBED AND REMOVED FROM WITHIN AREAS OF FOUNDATIONS AND PAVEMENTS OR PLANTING BEDS. ALL OTHERS SHALL BE REMOVED TO THE EXTENT NEEDED FOR 6" MIN. COVER OF FINAL GRADES.
- 5. DEMOLISH/REMOVE EXISTING CONCRETE PAVER WALK & PATIO.
- 6. EXTRACT EXISTING TREE AND HEEL-IN AND MAINTAIN OFF-SITE FOR RE-USE.
- 7. DEMOLISH/REMOVE EXISTING SLAB-ON-GRADE CONCRETE.
- DEMOLISH/REMOVE EXISTING DECK & STEPS AND FOUNDATIONS.
  SEE ARCHITECTURAL FOR ADDITIONAL INFORMATION.
- 9. DEMOLISH EXISTING STONE RETAINING WALL. SALVAGE STONE AND RE-USE IF USABLE.

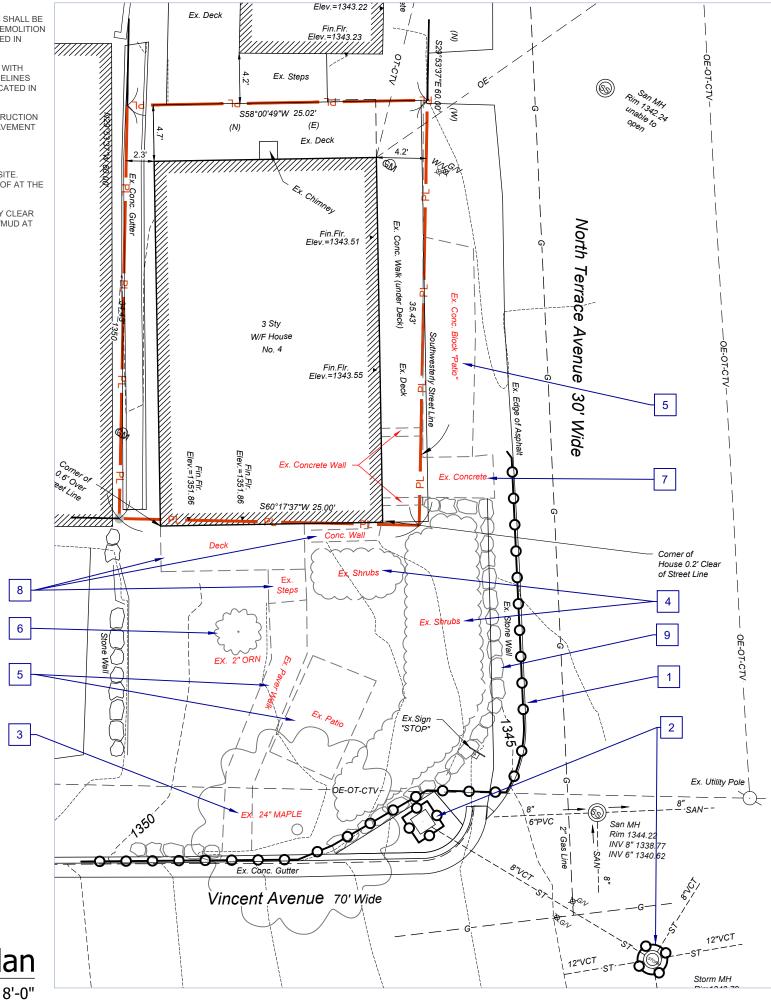

Landscape Architecture

5363 Dean Road

Stockton, New York 14784

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WALKERLY INUE

CLIENT: KRIS & TERRIE V 4 VINCENT AVEN CHAUTAUQUA, N

March 21, 2023

PROJECT:
Site & Landscape N
4 Vincent Avenue
Chautauqua, New )

**DRAWN BY:** JWR, PLB RE-ISSUE: MM.DD.YYYY

react 21, 2023 - 4:03pm Copyright 2023 Leaf+Stone Landscape Archite

N

Demo & Temporary E&S Control Plan

Scale: 1'' = 8'-0''

- SITE BASE MAP DEVELOPED EXISTING CONDITIONS AND TOPOGRAPHIC SITE SURVEY PREPARED BY RODGERS LAND SURVEYING DATED: 09/15/2022. CONTRACTOR SHALL CONTACT SURVEYOR FOR BENCHMARK INFORMATION AT (716) 665-2828.
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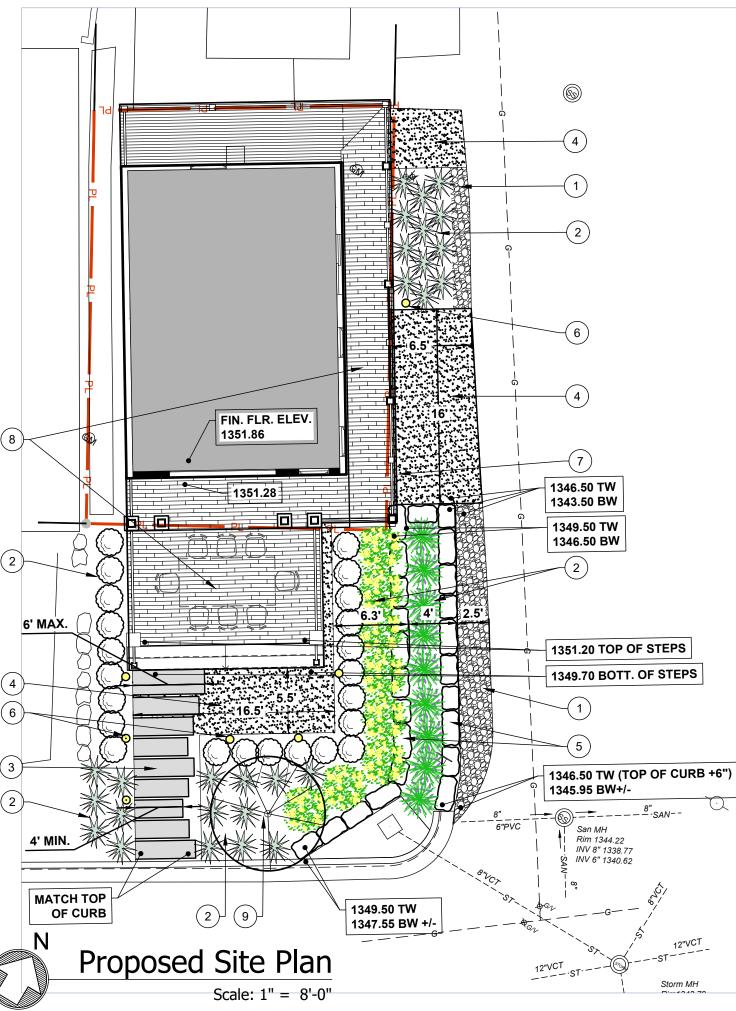
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#### 4 Vincent Ave - Propose Site Plan Surface Treatment Tabulation

				P	RIVATE PROPER	RTY	CH	CHAUTAUQUA INSTITUTION PROPERTY / STREET R.O.W.				
CATEGORY		DESCRIPTION	ACTUAL AREA (SF)	Credit (%)	TABULATION (sf):	Sub-total (sf)	Percentage of lot	ACTUAL AREA (SF)	Oredit (%)	TABULATION (sf)	Sub-total (sf)	Percentage of lot
TOTAL GREENSPACE						0	0%				828	71%
	100% РЕНМЕАВСЕ	All open / landscape areits void of structures or pavement elements.										
		Planting Beds	0.0	100%	0.0			502.0	100%	0.0		
		Permeable Aggregate Pavement	0.0	100%	0.0			245.0	100%	0.0	i.	
		Gravel Paths & Ornamental Stone Mulches	0.0	100%	0.0			81.0	100%	0.0		
		Lawn	0.0	100%	0.0			0.0	100%	0.0		
TOTAL IMPERVIOUS:						863	100%				336	29%
	STRUCTURES	Includes covered porches, window wells				772					200	
		Building w/ attached covered porch(s)	772.0	0%	772.0			200.0	0%	200.0		
	IMPERMEABLE LANDSCAPE ELEMENTS	Includes garden walls. Impermeable patics, sidewalks, driveways, etc.				92					100	
		Slab-oh-grade Concrete	91.5	0%	91.5			0.0	0%	0.0		
		Landscape & Retaining Walls	0.0	0%	0.0			100.0	0%	100.0	C.	
		Flagstones, Paving Slabs & stone steps	0.0	0%	0.0			0.0	0%	0.0		
	SEMI-PERMEABLE HARDSCAPE ELEMENTS	Includes permeable hardscape elements such as sidewalks, patios, driveways, wood-framed decks.				0					36	
		Flagstones & Paving Slabs on perm. base & joints	0.0	15%	0.0			42.0	15%	35.7		
		Permoable Paver Hardscape	0.0	15%	0.0			0.0	15%	0.0		
TOTAL SF OF PARCEL:			863.5					1,170,0				

#### SITE PLAN NOTES:

- (1. ) ORNAMENTAL STONE MULCH. 3"-6" DIA. RIVER-JACKS / COBBLES OVER WEED
- (2.) LANDSCAPING / PLANTING BED, PLANTINGS TBD.
- (3.) PATTERN-CUT FLAGSTONE PAVING SLABS. 18"W x  $2\frac{1}{4}$ " D x 48", 54" & 60" L. SET ON PERMEABLE CRUSHED STONE BASE WITH 2 1 JOINT.
- (4.) PERMEABLE AGGREGATE HARDSCAPE ORNAMENTAL OPEN-GRADED AGGREGATE CONFORMING TO ASTM No. 9 STONE INSTALLED WITH GRAVEL-LOK URETHANE-BINDER AND GRAVEL PAVE 2 CELLULAR REINFORCING GRID OVER PERMEABLE BASE COURSE
- (5.) LANDSCAPE / TERRACE "WALL" 30" MAX. HEIGHT PER WALL. RUSTIC-BUFF LIMESTONE BLOCKS FROM WWW.OHIOSTONE.COM . AVERAGE BLOCK SIZE: 16"H x 18"W x 30"L.
- (6.) LANDSCAPE PATH LIGHT MODEL TBD, TO BE DARK-SKY APPROVED WITH LIGHT DIRECTED DOWNWARD. LANDSCAPE LIGHTS SHALL BE SWITCHED FOR EASY ON/OFF. COORDINATE WITH ELECTRICIAN AND GENERAL CONTRACTOR FOR CONNECTION TO POWER AND SWITCHING. (TYPICAL OF 7)
- BICYCLE STORAGE AT FORMER LOCATION OF TRASH RECEPTACLES.
- (8.) PORCH / DECK, SEE ARCHITECTURAL PLANS
- (9.) ORNAMENTAL SPECIMEN TREE, SINGLE LEADER WITH 25'+/- MATURE HEIGHT. SPECIES TBD.



Landscape Architecture

5363 Dean Road Stockton, New York 14784 www.LeafandStone.design

716-952-4666

WALKERLY INUE 14712 CLIENT: KRIS & TERRIE W 4 VINCENT AVEN CHAUTAUQUA, N

**DATE:** March 21, 2023

RE-ISSUE: MM.DD.YYYY

PROJECT: Site & Landscape Master F 4 Vincent Avenue Chautauqua, New York

ΒΥ:


DRAWN

- 1. SITE BASE MAP DEVELOPED EXISTING CONDITIONS AND TOPOGRAPHIC SITE SURVEY PREPARED BY RODGERS LAND SURVEYING DATED: 09/15/2022. CONTRACTOR SHALL CONTACT SURVEYOR FOR BENCHMARK INFORMATION AT (716) 665-2828.
- 2. EXISTING UTILITY LOCATIONS SHOWN ARE APPROXIMATE ONLY CONTRACTOR SHALL VERIFY LOCATIONS OF ALL UTILITIES ON SITE PRIOR TO BEGINNING EXCAVATION ADDITIONAL UTILITIES. MAY BE PRESENT IN ADDITION TO THOSE INDICATED IN THE
- 3. UNDERGROUND UTILITIES EXIST, CONTRACTOR SHALL BE RESPONSIBLE FOR CALLING 811DIG-SAFE FOR UTILITY MARK-OUT PRIOR TO THE COMMENCEMENT OF ANY WORK.
- 4. THE CONTRACTOR SHALL COORDINATE WITH UTILITY PROVIDERS FOR INSTALLATION AND CONNECTION OF UTILITIES WITH OTHER TRADES.
- 5. ALL TEMPORARY SEDIMENT AND EROSION CONTROLS SHALL BE


- INSTALLED PRIOR TO THE COMMENCEMENT OF ANY DEMOLITION OR EARTH-WORK ACTIVITIES AND SHALL BE MAINTAINED IN GOOD WORKING ORDER.
- 6. EARTHWORK SHALL BE PERFORMED IN ACCORDANCE WITH REQUIREMENTS OUTLINED IN "NEW YORK STATE GUIDELINES FOR EROSION AND SEDIMENT CONTROL" AND AS INDICATED IN THE PROJECT SPECIFICATIONS.
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- CONTRACTOR SHALL KEEP A CLEAN AND TIDY WORK SITE. TRASH AND LITTER TO BE PICKED -UP AND DISPOSED OF AT THE CLOSE OF EACH DAY.
- 10. THE CONTRACTOR SHALL KEEP THE PUBLIC ROADWAY CLEAR OF DEBRIS AND SHALL CLEAN TO REMOVE DIRT/DUST/MUD AT THE END OF EACH WORK DAY.

#### 4 Vincent Ave - Propose Site Plan Surface Treatment Tabulation

				P	RIVATE PROPER	RTY		CH	AUTAUC	/ STREET R.O		RTY
CATEGORY		DESCRIPTION	ACTUAL AREA (SF)	Credit (%)	TABULATION (sf)	Sub-total (sf)	Percentage of lot	ACTUAL AREA (SF)	Gredit (%)	TABULATION (sf)	Sub-total (sf)	Percentage of lot
TOTAL GREENSPACE						0	0%				828	71%
	100% PERMEABLE	All open I landscape areas void of structures or pavement elements.										
		Planting Beds	0.0	100%	0.0			502.0	100%	0.0	1.0	
		Penneable Aggregate Pavement	0.0	100%	0.0			245.0	100%	0.0		
		Gravel Paths N Ornamental Stone Mulches	0.0	100%	0.0			81.0	100%	0.0		
		Lawn	0.0	100%	0.0			0.0	100%	0.0		
TOTAL IMPERVIOUS:						863	100%				336	29%
	STRUCTURES	Includes covered porches, window wells				772					200	
		Building w/ attached covered parch(s)	772.0	0%	772.0			200.0	0%	200.0	31	
	IMPERMEABLE LANDSCAPE ELEMENTS	Includes garden walls, impermeable patios, sidewalks, driveways, etc.				92					100	
		Slab-on-grade Concrete	91.5	0%	91.5			0.0	0%	0.0		
		Landscape & Retaining . Walls	0.0	0%	0,0			100.0	0%	100.0		
		Flagstones, Paving Slabs & stone steps	0.0	0%	0.0			0.0	0%	0.0		
	SEMI-PERMEABLE HARDSCAPE ELEMENTS	Includes permeable hardscape elements such as sidewalks, patios, driveways, wood-framed decks.				0					36	
		Flugstones & Paving Slubs on perm. base & joints	0.0	15%	0.0			42.0	15%	35.7		
		Permeable Paver Hardscape	0.0	15%	0.0			0.0	15%	0.0		
TOTAL SF OF PARCEL:			863.5					1,170.0				

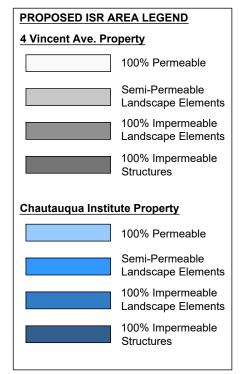



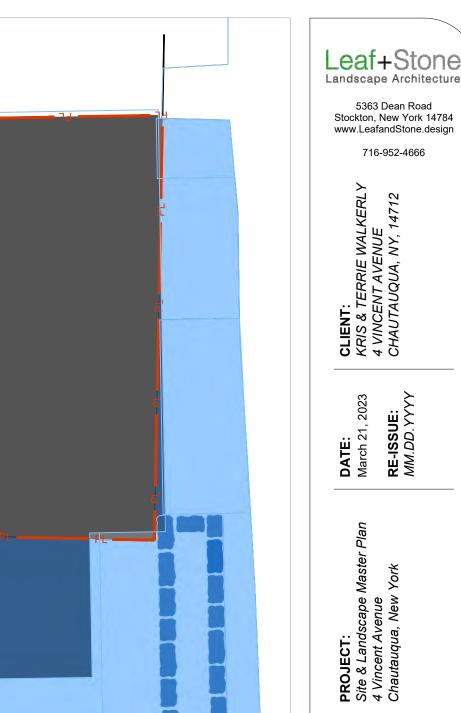

DRAWN BY: JWR



Proposed Surface Treatement Ground Figure

5363 Dean Road Stockton, New York 14784 www.LeafandStone.design

716-952-4666

CLIENT: KRIS & TERRIE WALKERLY 4 VINCENT AVENUE CHAUTAUQUA, NY, 14712

**DATE:** March 21, 2023 RE-ISSUE: MM.DD.YYYY

PROJECT: Site & Landscape Master Plan 4 Vincent Avenue Chautauqua, New York

**DRAWING TITLE**: SITE DETAILS **DRAWN BY:** JWR, PLB

3.0

NO SCALE

on Permeable Base

5363 Dean Road Stockton, New York 14784 www.LeafandStone.design

716-952-4666

CLIENT:
KRIS & TERRIE WALKERLY
4 VINCENT AVENUE
CHAUTAUQUA, NY, 14712

**DATE:** March 21, 2023 RE-ISSUE: MM.DD.YYYY

PROJECT: Site & Landscape Master Plan 4 Vincent Avenue Chautauqua, New York

**DRAWING TITLE:**SITE DETAILS **DRAWN BY:** JWR, PLB

3.1

NO SCALE

Permeable Aggregate Hardscape with Reinforcing Grid L 3.1

- SITE BASE MAP DEVELOPED EXISTING CONDITIONS AND TOPOGRAPHIC SITE SURVEY PREPARED BY RODGERS LAND SURVEYING DATED: 09/15/2022. CONTRACTOR SHALL CONTACT SURVEYOR FOR BENCHMARK INFORMATION AT (716) 665-2828.
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CATEGORY		DESCRIPTION	ACTUAL AREA (SF)	Credit (%)	TABULATION (#f)	Sub-total (cil)	Percentage of lot	ACTUAL AREA (SF)	Credit (%)	TABULATION (H)	Sub-total (sf)	Percentage of lot
TOTAL GREENSPACE						0	.0%				855	73%
	100% PERMEABLE	All open i lunoscape unse. void of structures or pavement elements.										
		Planting Beds	0.0	100%	0.0			504.0	100%	0.0		
		Permeable Aggregate Pavement	0.0	100%	0.0			270.0	100%	0.0		
		Gravel Paths & Ornamental Stone Mulches	D.0	100%	0.0			81.0	100%	0.0		
		Lawn	0.0	100%	0.0			0.0	100%	0.0		
TOTAL IMPERVIOUS:						863	100%				290	25%
	STRUCTURES	Includes covered porches, window wells				772					45	
		Building w/ attached covered parch(s)	772.0	0%	772,0			45.0	0%	45,0	A.	
	IMPERMEABLE LANDSCAPE ELEMENTS	Includes garden walls, impermeable patios, sidewalks, driveways, etc.				92					100	
		Slab-on-grade Concrete	91.5	0%	91.5			0.0	0%	0.0		
		Landscape & Retaining Walls	0.0	0%	0.0			100.0	0%	100.0		
		Flagstones, Paving Slabs & stone steps	0.0	0%	0.0			0.0	0%	0.0		
	SEMI-PERMEABLE HARDSCAPE ELEMENTS	Includes permeable hardscape elements such as sidewalks, patios, driveways, wood-framed decks,				0					145	
		Flagstones & Paving Slabs on perm. base & joints	0.0	15%	0.0			170.0	15%	144.5		
		Permeable Paver Hardscape	0.0	15%	0.0		15	0.0	15%	0.0		
TOTAL SF OF PARCEL:			863.5					1,170.0				

#### SITE PLAN NOTES:

- (1.) ORNAMENTAL STONE MULCH. 3"-6" DIA. RIVER-JACKS / COBBLES OVER WEED
- (2.) LANDSCAPING / PLANTING BED, PLANTINGS TBD.
- (3.) PATTERN-CUT FLAGSTONE PAVING SLABS. 18"W x  $2\frac{1}{4}$ " D x 48", 54" & 60" L. SET ON PERMEABLE CRUSHED STONE BASE WITH 2 1 JOINT.
- (4.) PERMEABLE AGGREGATE HARDSCAPE ORNAMENTAL OPEN-GRADED AGGREGATE CONFORMING TO ASTM No. 9 STONE INSTALLED WITH GRAVEL-LOK URETHANE-BINDER AND GRAVEL PAVE 2 CELLULAR REINFORCING GRID OVER PERMEABLE BASE COURSE
- (5.) LANDSCAPE / TERRACE "WALL" 30" MAX. HEIGHT PER WALL. RUSTIC-BUFF LIMESTONE BLOCKS FROM WWW.OHIOSTONE.COM . AVERAGE BLOCK SIZE: 16"H x 18"W x 30"L.
- (6.) LANDSCAPE PATH LIGHT MODEL TBD, TO BE DARK-SKY APPROVED WITH LIGHT DIRECTED DOWNWARD. LANDSCAPE LIGHTS SHALL BE SWITCHED FOR EASY ON/OFF. COORDINATE WITH ELECTRICIAN AND GENERAL CONTRACTOR FOR CONNECTION TO POWER AND SWITCHING. (TYPICAL OF 9)
- ) BICYCLE STORAGE AT FORMER LOCATION OF TRASH RECEPTACLES.
- (8.) PORCH / DECK, SEE ARCHITECTURAL PLANS
- (9.) ORNAMENTAL SPECIMEN TREE, SINGLE LEADER WITH 25'+/- MATURE HEIGHT. SPECIES TBD.



Landscape Architecture

5363 Dean Road Stockton, New York 14784 www.LeafandStone.design

716-952-4666

WALKERLY ENUE CLIENT: KRIS & TERRIE W 4 VINCENT AVEN CHAUTAUQUA, N

**DATE:** March 21, 2023

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PROJECT:
Site & Landscape Master F
4 Vincent Avenue
Chautauqua, New York


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	IMPERMEABLE LANDSCAPE ELEMENTS	Includes garden walls, impermeable patios, sidewalks, driveways, etc.				92					100	
		Slab-on-grade Concrete	91.5	0%	91.5			0.0	0%	0.0		
		Landscape & Retaining Walls	0.0	0%	0.0			100.0	0%	100.0		
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TOTAL SF OF PARCEL:			863.5					1,170.0				





Alternate Surface Treatment Ground Figure

Scale: 1" = 8'-0"

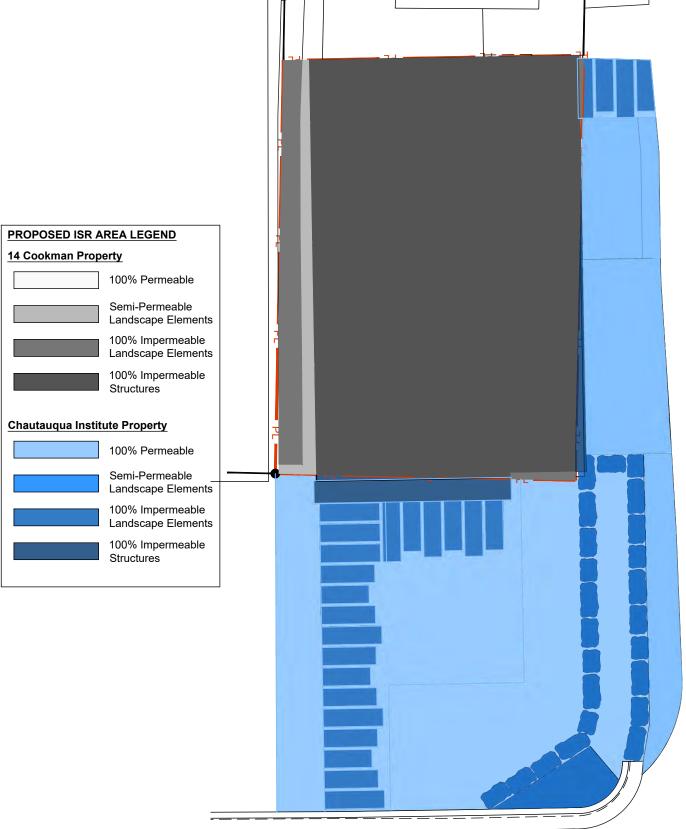716-952-4666


CLIENT:
KRIS & TERRIE WALKERLY
4 VINCENT AVENUE
CHAUTAUQUA, NY, 14712

**DATE:** March 21, 2023

PROJECT: Site & Landscape Master Plan 4 Vincent Avenue Chautauqua, New York


DRAWN BY: JWR

# **OPTION "B"**

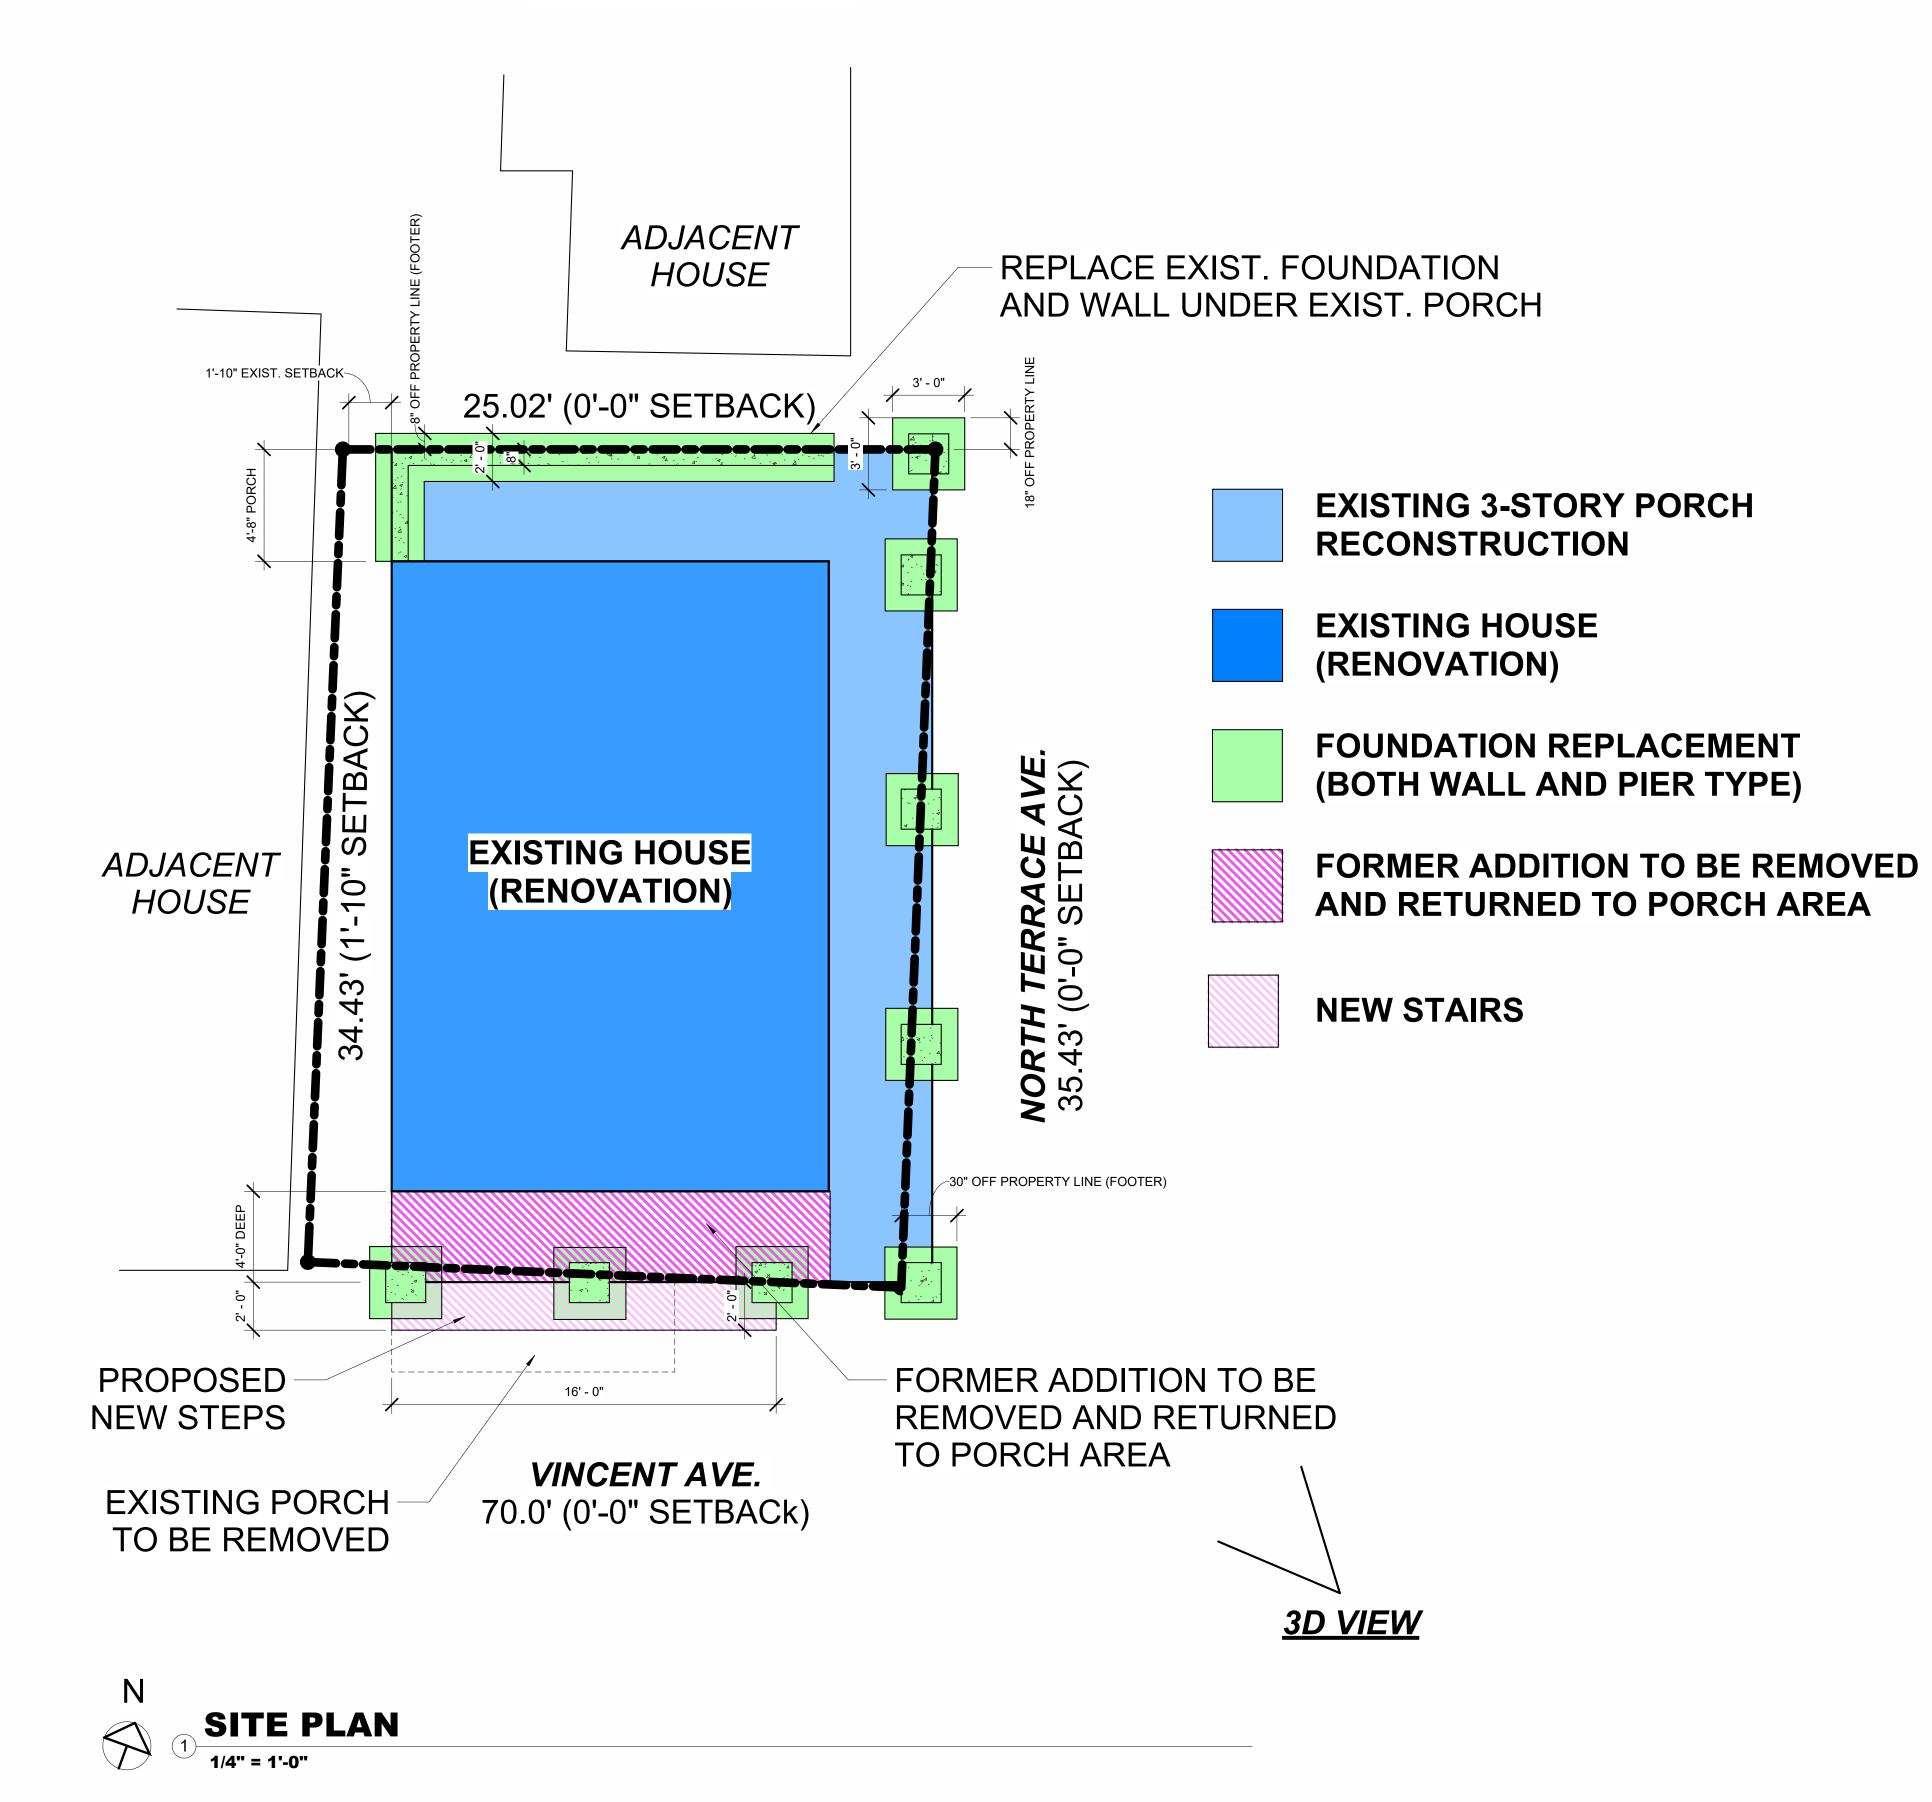



**CORNER 3D VIEW** 

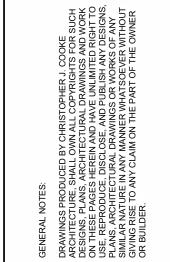

AS COOKE ACHITECTURE, P.C.

Cooke Architecture, P.C.

itecture.com 716-228-0520

WALKERLY RESIDENCE

4 VINCENT AVENUE
CHAUTAUQUA, NEW YORK 14722

VISION REVISION IMBER DATE


SCALE: 1/4" = 1'-0"


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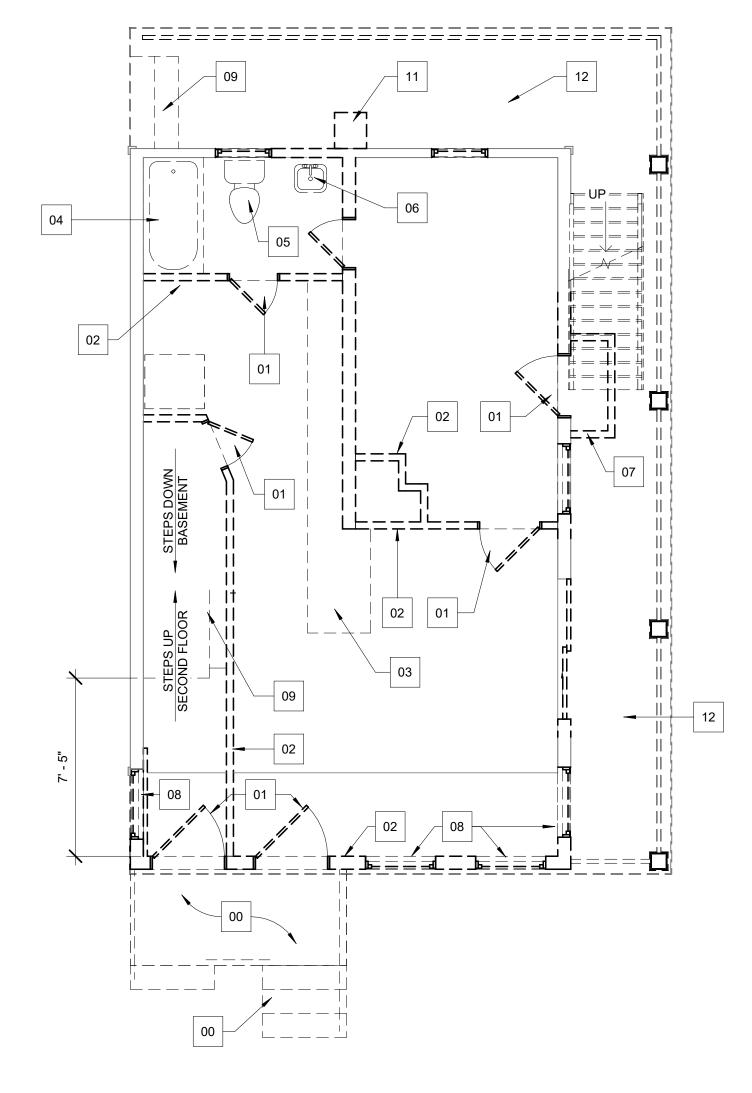
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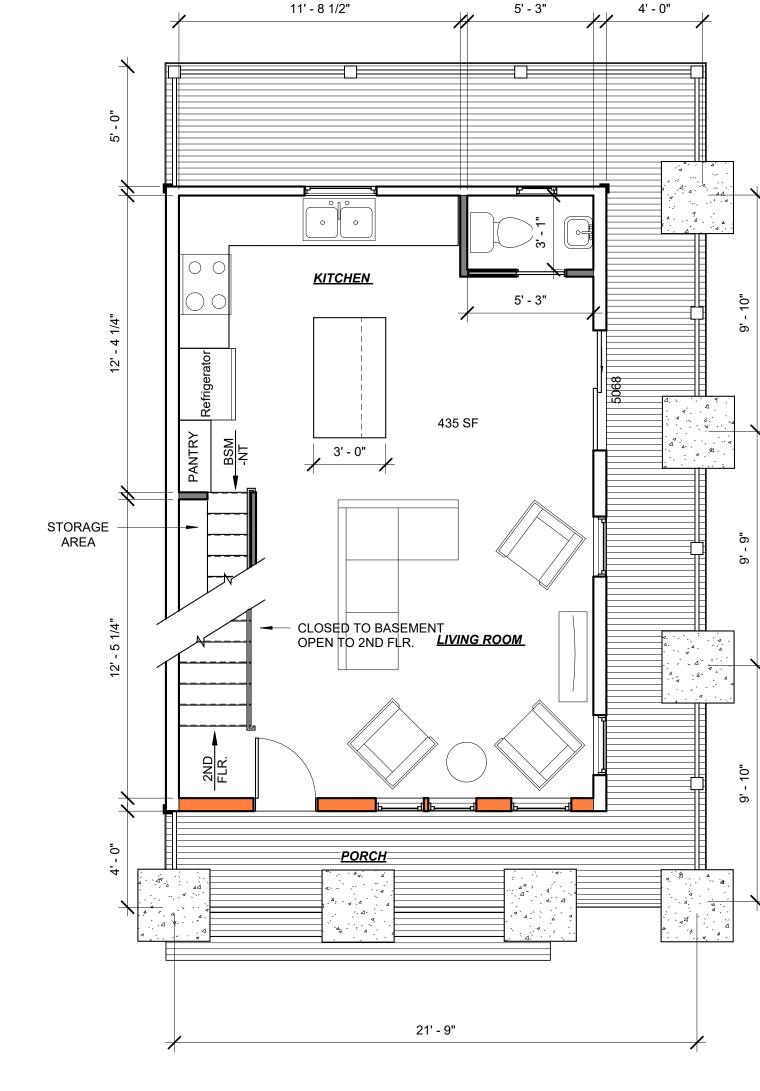
ECT NUMBER: 22-116

SHEET NUMBER:





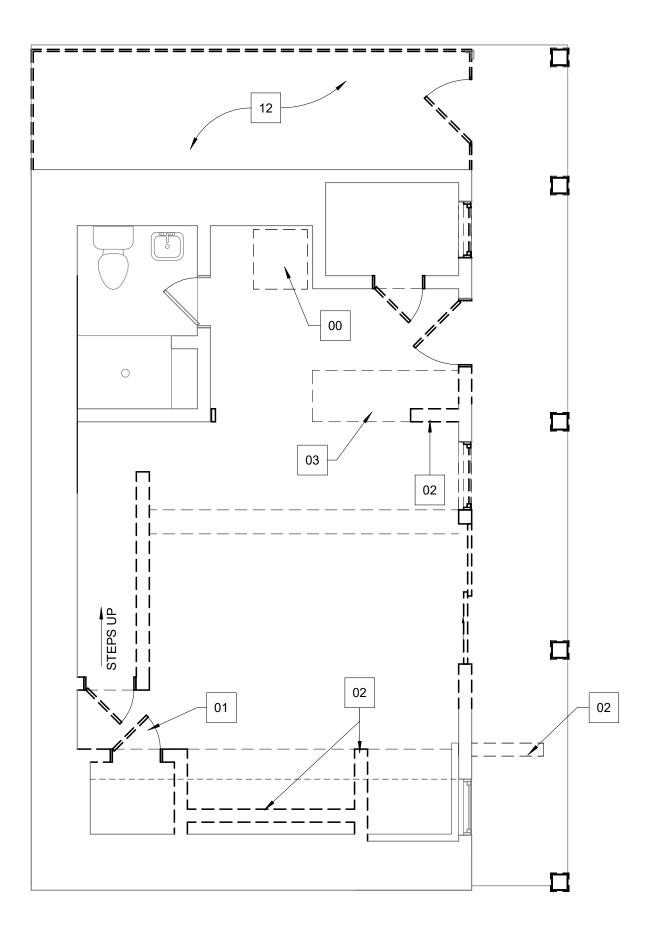

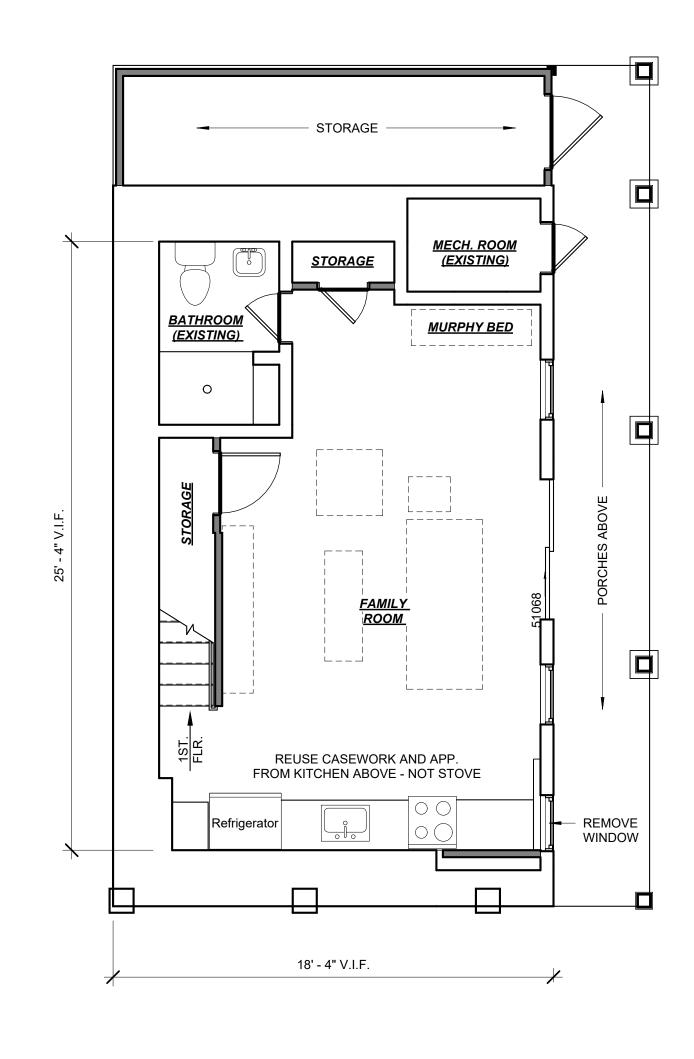

# **BASEMENT (DEMO PLAN)**1/4" = 1'-0"

EXISTING DOOR(S) TO BE REMOVED.

EXISTING WALL(S) TO BE REMOVED

EXISTING KITCHEN COUNTER(S), FIXTURE(S), CASEWORK, AND APPLIANCE(S) TO BE REMOVED

EXISTING SHOWER/TUB TO BE REMOVED

EXISTING TOILET(S) TO BE REMOVED

EXISTING SINK/VANTY TO BE REMOVED

EXISTING CLOSET TO BE REMOVED

EXISTING WINDOW(S) TO BE REMOVED

EXISTING STAIR(S) TO BE REMOVED

EXISTING EXTERIOR STORAGE TO BE REMOVED

EXISTING CHIMNEY TO BE REMOVED

EXISTING PORCHES TO RECONSTRUCTED (FLOORS, CEILINGS, COLUMNSS, RAILS)

## **DEMOLITION NOTES**

**1 1/2" = 1'-0"** 

3 BASEMENT (PROPOSED)
1/4" = 1'-0"

FIRST FLOOR (DEMO PLAN)

1/4" = 1'-0"

FIRST FLOOR (PROPOSED)

1/4" = 1'-0"








SCALE: As indicated DATE: 03-22-23


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SHEET NUMBER:



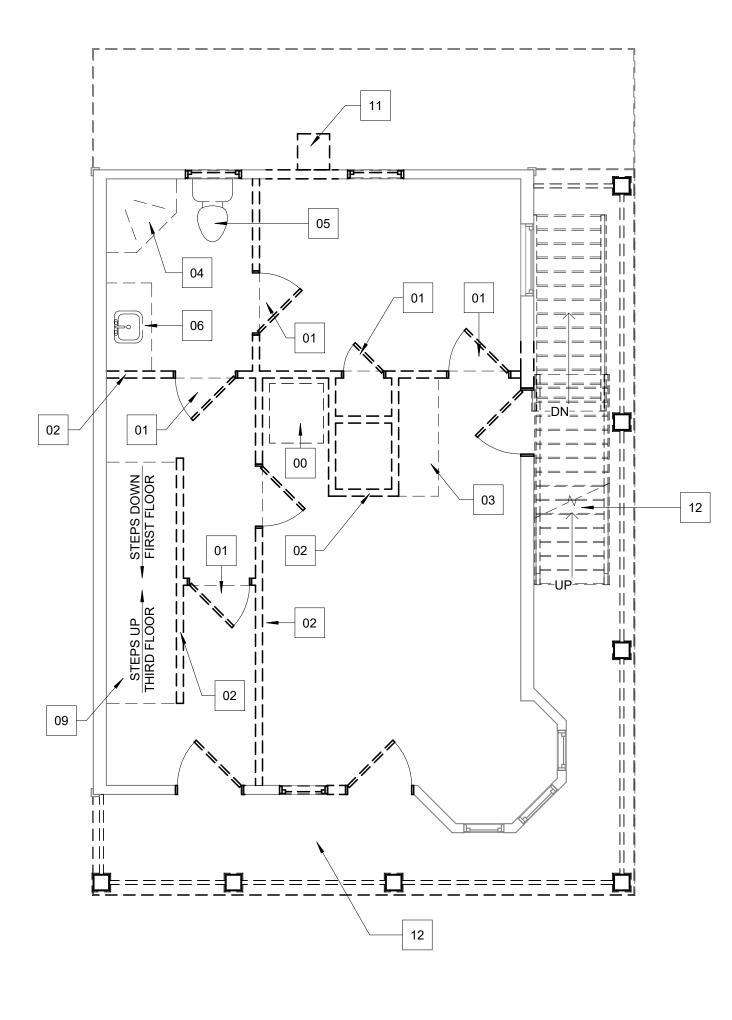

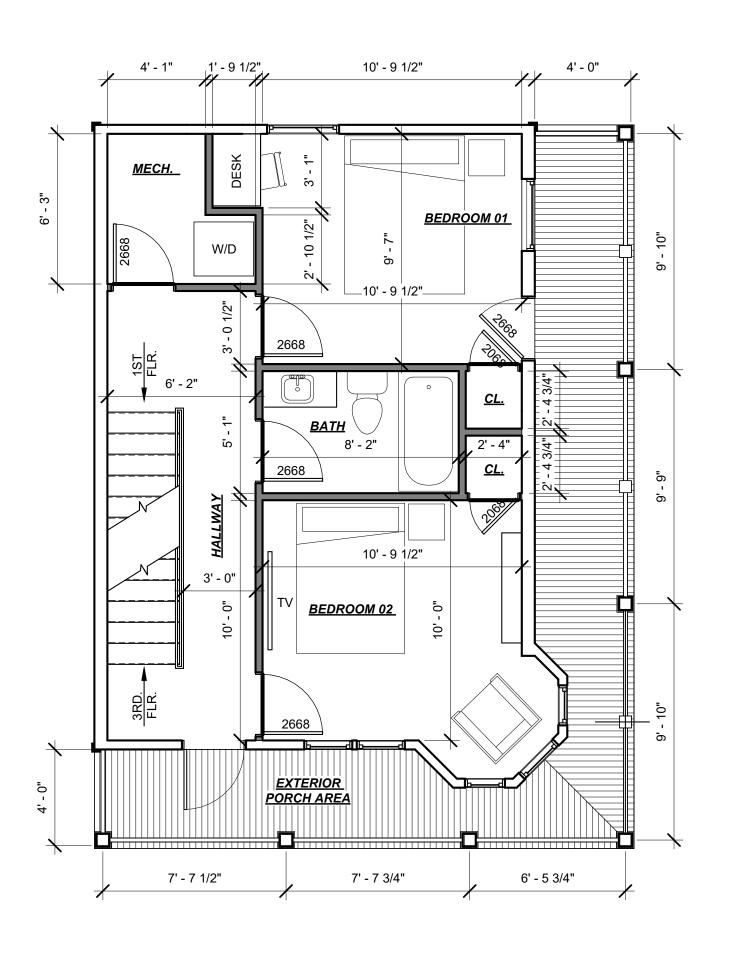

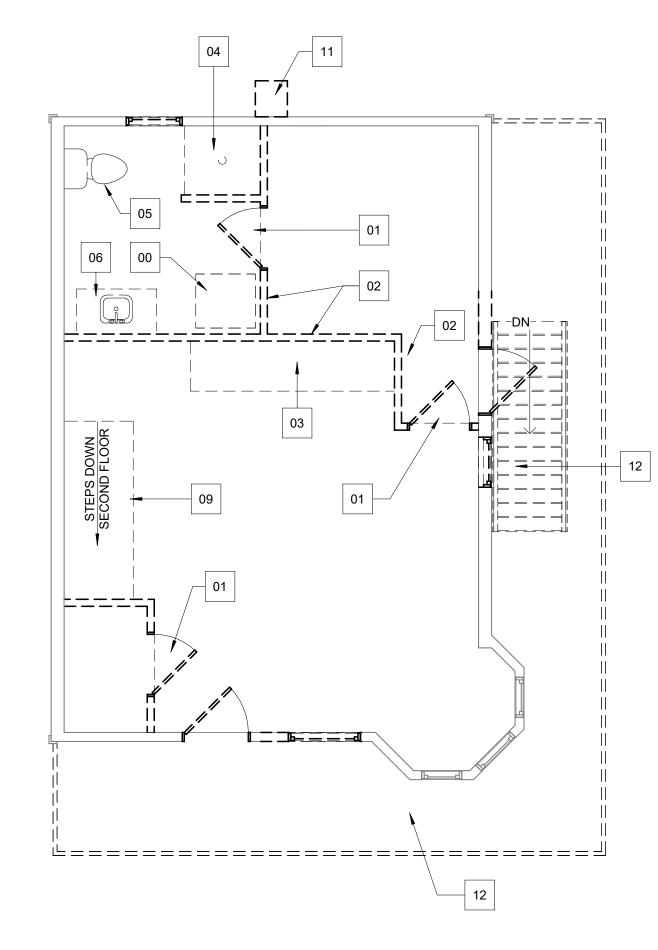
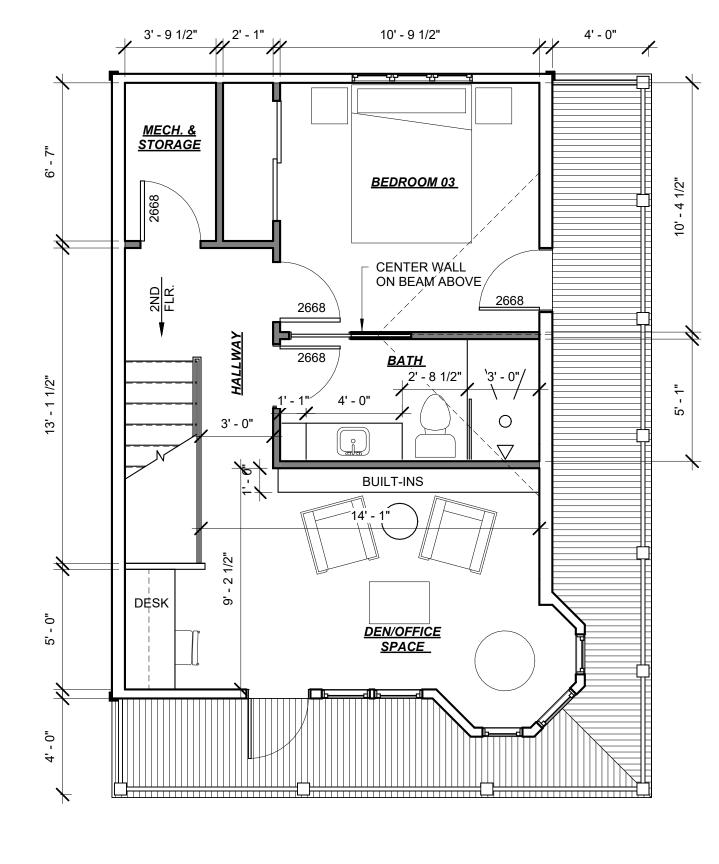
# SECOND FLOOR (DEMO PLAN) 1/4" = 1'-0"

SECOND FLOOR (PROPOSED)

1/4" = 1'-0"

THIRD FLOOR (DEMO PLAN)

1/4" = 1'-0"

THIRD FLOOR (PROPOSED)

1/4" = 1'-0"

01	EXISTING DOOR(S) TO BE REMOVED.	
----	---------------------------------	--

02 EXISTING WALL(S) TO BE REMOVED

03 EXISTING KITCHEN COUNTER(S), FIXTURE(S), CASEWORK, AND APPLIANCE(S) TO BE REMOVED

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EXISTING SINK/VANTY TO BE REMOVED

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## **DEMOLITION NOTES**

EXISTING EXTERIOR STORAGE TO BE REMOVED

5 1 1/2" = 1'-0"

GENERAL NOTES:

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OR BUILDER.

CHRIS COOKE

A R C H I T E C T U R E

Christopher J. Cooke Architecture, P.C.

chris@cjcarchitecture.com 716-228-0520
80 Maple Avenue - Cassadaga, New York 14718

ALKERLY RESIDENCE

4 VINCENT AVENUE
CHAUTAUQUA INSTITUTION

ON REVISION PR DATE


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DATE: 03-22-23

DRAWN BY: CC

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NORTH TERRACE AVENUE


SIDE ELEVATION - EXISTING

1/4" = 1'-0"

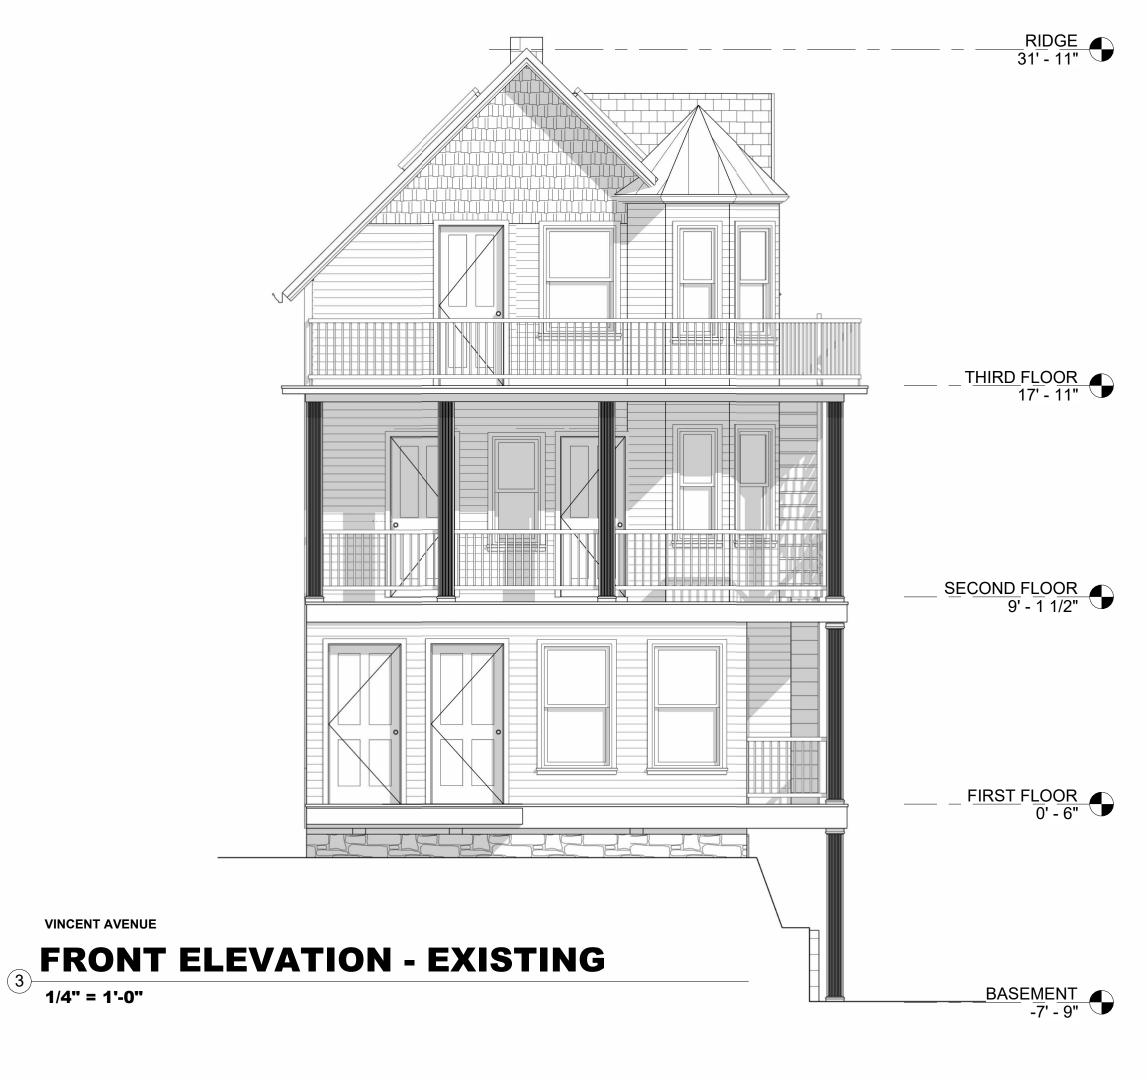
NORTH TERRACE AVENUE

SIDE ELEVATION - PROPOSED

1/4" = 1'-0"

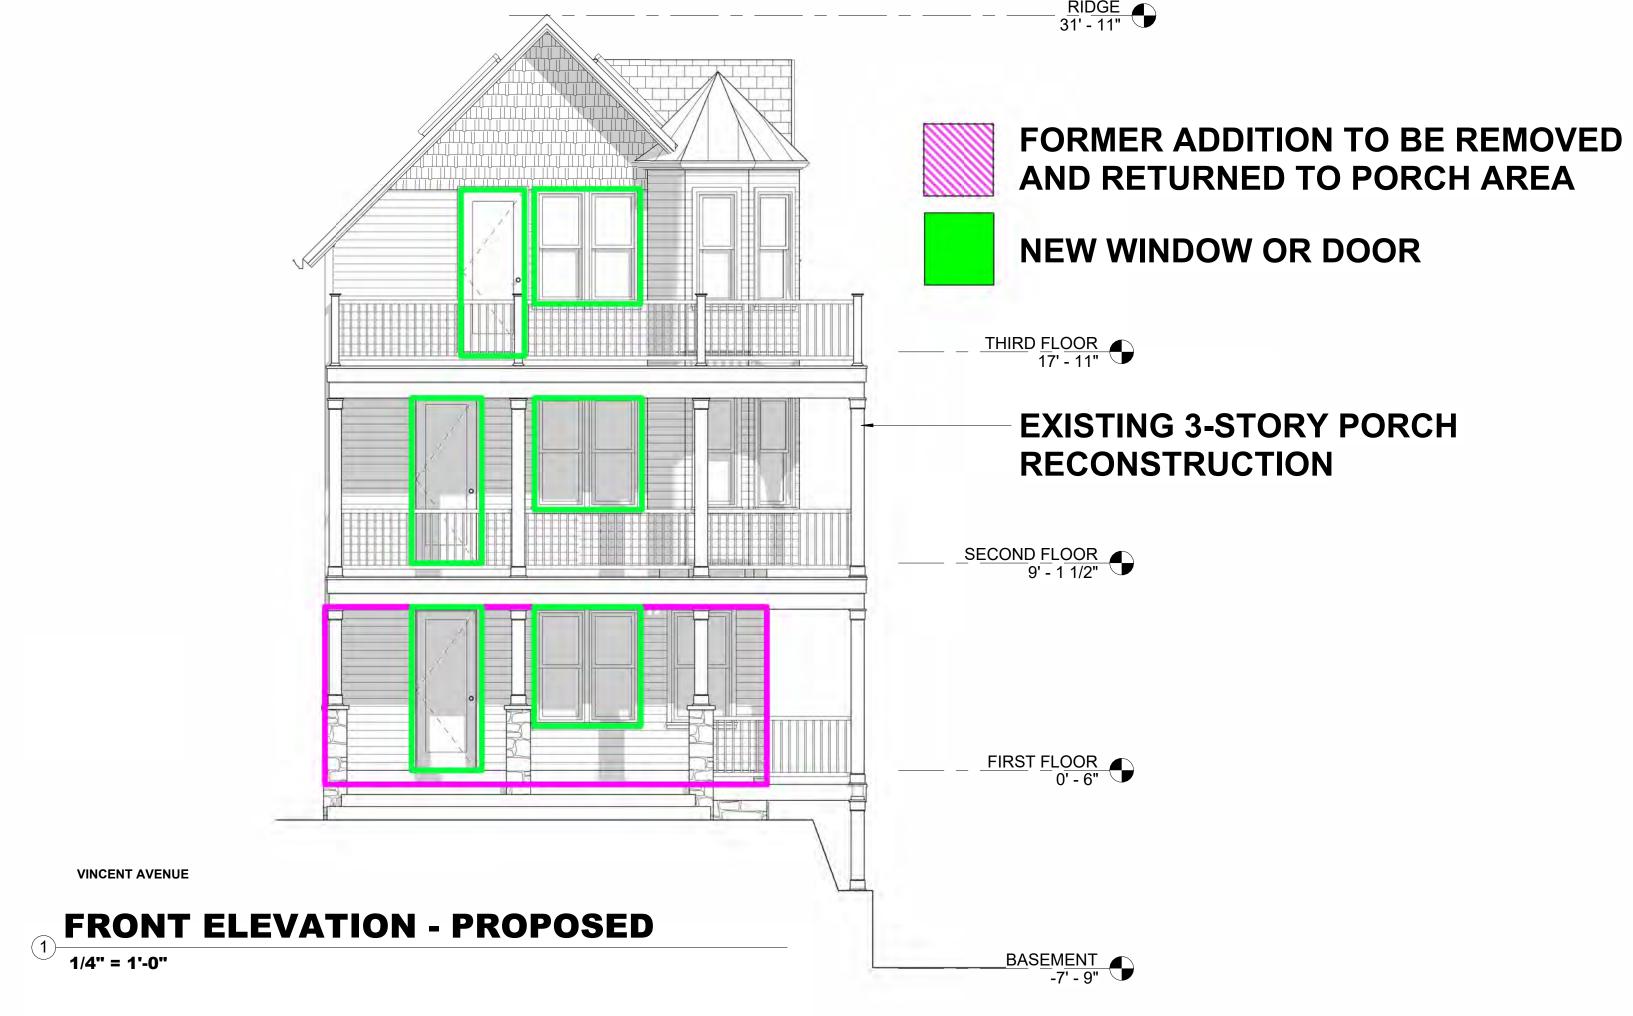



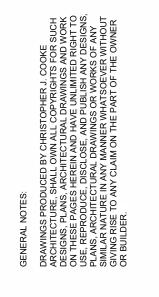

HRIS COOKE TO RE topher J. Cooke Architecture, P.C. @cjcarchitecture.com 716-228-0520



WALKERLY RESIDENCE

4 VINCENT AVENUE
CHAUTAUQUA, NEW YORK 14722

ON REVISION R DATE

SCALE: 1/4" = 1'-0"

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DATE: 03-22-23

RAWN BY: CC/DK


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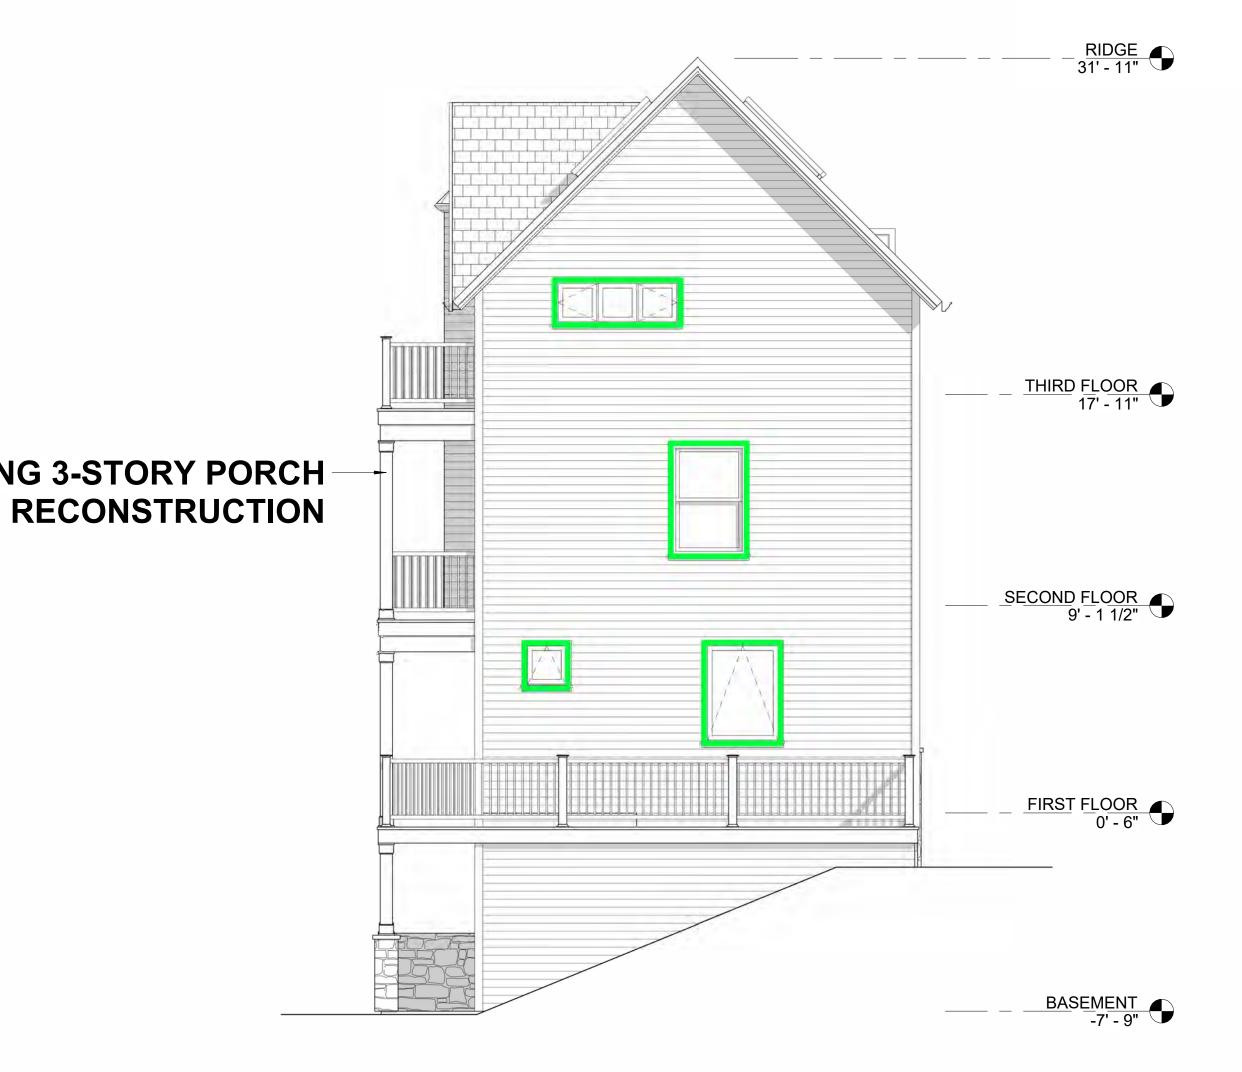


# WEST ELEVATION - EXISTING




# REAR ELEVATION - EXISTING 1/4" = 1'-0"

# **WEST ELEVATION - PROPOSED**

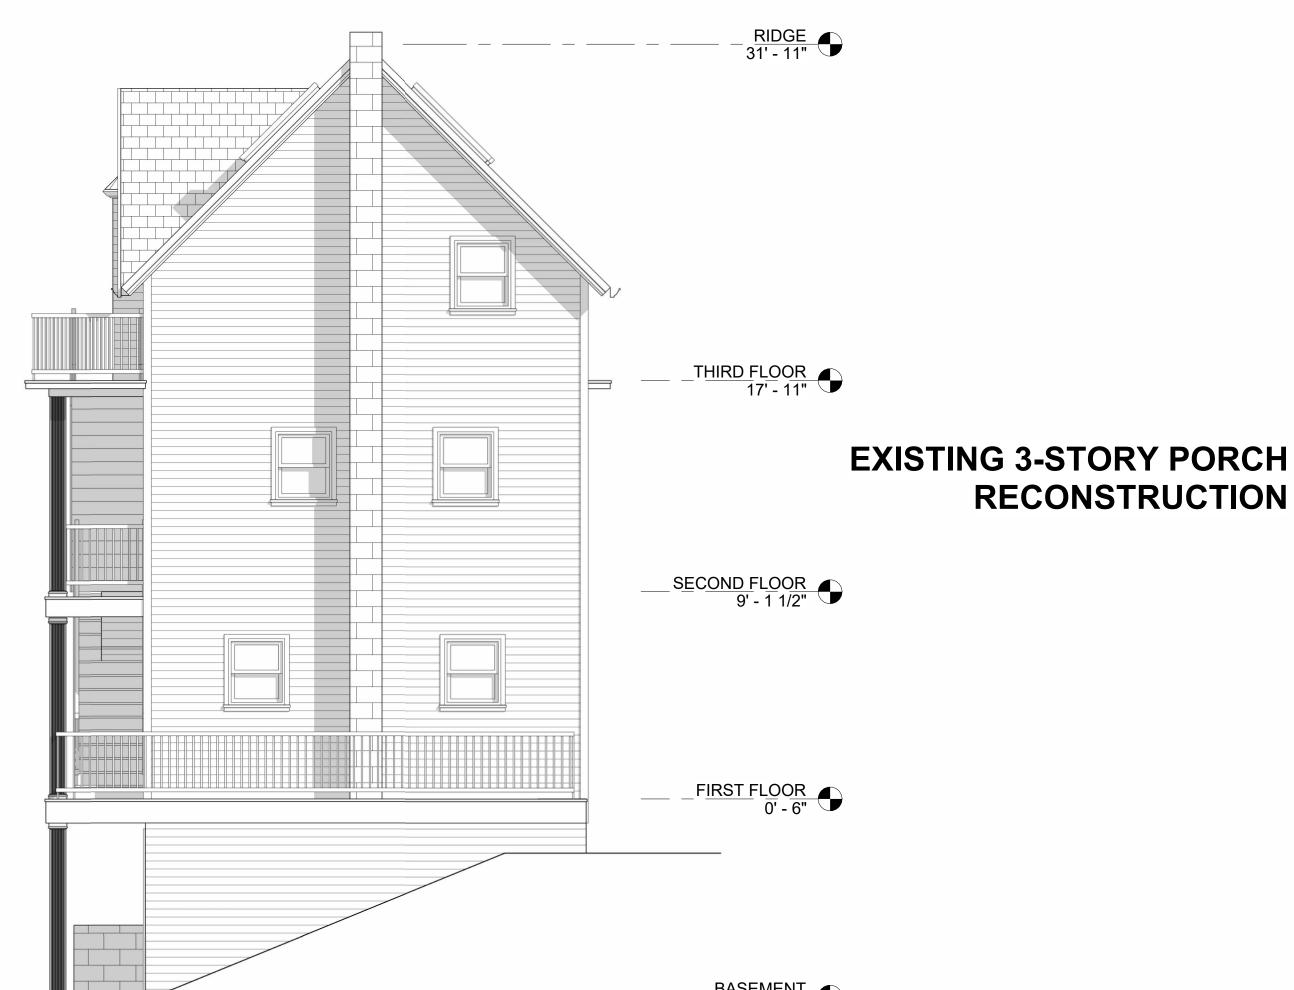

## **REAR ELEVATION - PROPOSED**

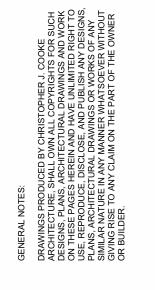





SCALE: 1/4" = 1'-0" DATE: 03-22-23

SHEET NUMBER:

#### Office Use ONLY

Remin	ation Received: est Investigated by			_ By Email	Date
	Approved:	( ) YES	( ) NO	)	Date
	nmend to ARB:				Date
		( ) YES			Date
	Issued By				
	Notes				
+++	+++++++++	+++++++	++++++	+++++++++++	++++++++++++++++++++++++++++
			CHAUT	AUQUA INSTITU	JTION
AF	RCHITECTU	RAL AND	LAND U	SE COMPLIANC	E CERTIFICATE APPLICATION
Chau	utauqua Institu	ution has ad	lopted spe	cific regulations for	ALL construction, landscaping and
use o	of properties of	on the groun	nds. All co	instruction work (	except routine maintenance; interior
finish	nes, non-struc	tural interio	r alteration	ns; kitchen/bath alte	erations; interior mechanical systems;
exter	rior painting) r	nust first b	e reviewe	ed and approved b	y the Administrator of
Arch	itectural & L	and Use Re	egulations	s prior to starting.	(See Compliance Process Matrix
3.3 in	n Regulation	s). A curre	ent, valid (	Compliance Certif	icate from the Institution MUST BE
POS	TED on the s	ite for this w	vork. A To	wn of Chautauqua	a Building Permit may also be
requ	ired from the	Town of	Chautauq	ua.	
		PLEA	SE FILL I	N FOLLOWING IN	FORMATION:
		Ť	ERRY WA	I KERI Y & KRIS F	PUTNAM-WALKERLY
4)	Owner's Na	ime	LIXIXI VV	TENEFIC CITATO	
	Chautaugu	a Address	4 VIN	ICENT AVENUE	
	Darmanan	Addross.	21650	7 Tradowin	ds Dr., Avon Lake OH 4401
					7.101.10-10-00.
		hone #(5			cell #SAME
	Owner's e-	- I KDI	CODUTAL	AM-CONSULTING	.COM_TERRY@FRYERMANAGEMENT
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<b>D</b> \				Λ	
В)		n Site Hous		Λ	/ Unit #
	Construction	on Site Hous	se Number	r4	/ Unit #
	Construction  District of C	on Site House	se Number	r4 Mixed Use Core	/ Unit #  ( ) Neighborhood Traditional
	Construction  District of C  ( ) Neight	on Site House Construction Corhood Su	se Numbe n Site: (X) l burban	r4 Mixed Use Core ( ) Miller Park	/ Unit #
	Construction  District of C  ( ) Neight	on Site House	se Numbe n Site: (X) l burban	r4 Mixed Use Core ( ) Miller Park	/ Unit #  ( ) Neighborhood Traditional
C)	District of C ( ) Neight ( ) Garde	on Site House Construction Corhood Su n District	se Number n Site: (X) l burban ( ) \	r4 Mixed Use Core ( ) Miller Park Woodlands (	/ Unit #  ( ) Neighborhood Traditional ( ) Suburban Multi-Family ) Highlands
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B) C) D)	District of C ( ) Neight ( ) Garde  Prime Cont	Construction Construction Corhood Su n District tractor / CM CONTRAC Contrac ctor (Names	se Number  Site: (X) In  burban  ( ) N  I(Names, Fo.467.1112  Stor Authoris  & Phone	r4  Mixed Use Core ( ) Miller Park  Woodlands ( Phone Numbers, e ALEXANDERCON  ization Certificate # Numbers)	/ Unit #  ( ) Neighborhood Traditional ( ) Suburban Multi-Family ) Highlands  mail address)JIM_ALEXANDER NSTRUCTION2000@YAHOO.COM
C)	District of C ( ) Neight ( ) Garde  Prime Cont CONSTRU	Construction Construction Corhood Su n District  tractor / CM CTION 716  Contractor (Names Contractor (Names	se Number  n Site: (X) I burban ( ) \ I(Names, F 6.467.1112 ctor Authori s & Phone ctor Author	Mixed Use Core ( ) Miller Park Woodlands ( Phone Numbers, e- ALEXANDERCON ization Certificate # Numbers)	/ Unit #
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(X) Porches/Decks/Patios/Pergolas/Balconies ( ) Site Features or change of grade

( ) New Construction

( ) Exterior HVAC/ Mechanical Units ( ) Roofs

	( ) New Awnings ( ) Additions ( X ) Reconstruction ( ) Renovation ( ) Garage ( ) Other
	E.2) Description of Work (Attach additional sheets and/or drawings if available):  See architectural and landscape drawings attached.
<b>E</b> /	Date Work Is Expected To Begin <u>FALL 2023 To Finish By SPRING 2024</u>
F)	
G)	Selected historic preservation classification: (See 4.12 in Regulations)
	( ) Preservation ( x )Reconstruction ( ) Rehabilitation ( )Restoration
H)	Proposed Materials: (plastic, vinyl are prohibited)Composite trim, decking, handrails
I)	Identify the industry recognized architectural style:
J)	Identify tree disturbances (within canopy) and/or proposed removals: See landscape plans
K)	Describe how site drainage during construction and after construction will be managed in compliance with Regulations (attach drawings if necessary):Runoff will be captured on-site.
L)	Describe how you will manage legal off-street parking on the project site:CHQ ALU regulations will be followed.
M)	THE INSTITUTION STAFF CANNOT GRANT SPECIAL EXCEPTIONS TO, OR VARIANCES FROM, THE ARCHITECTURAL AND LAND USE REGULATIONS. PLEASE INDICATE BELOW IF THE WORK IS SUCH THAT ACTION FROM THE ARCHITECTURAL REVIEW BOARD (ARB) IS REQUIRED.
	Variance Is Being RequestedYESNO Special Exception is RequestedYESNO Describe Variances/Exception Requested See document below.
N)	Lot Size, Intensity, Impervious Surface Ratio: (See Regulations for definitions)
	Lot Width: 25' x 35.43' Lot Area: 875sf Floor/Area Ratio: Existing = 2.27
	Impervious Surface Ratio: Proposed = 2.19
O)	Height to Eave: 21'-6" Height to Highest Ridge/Point: 31'-5"
P)	I agree to reimburse Chautauqua Institution for all costs, repairs and/or construction to any road surface and/or right-of-way resulting from construction activities X_YESNO

#### 4 VINCENT – ARB VARIANCE REQUESTS Option A (Preferred):

- Seeking permission for the removal of the existing ~24" Dia. Maple tree located at the curb line within the front yard right-of-way (ROW). (The tree has a significant lean out over the road and utility lines and the roots are causing displacement of adjacent pavements.)
  - o The property owner would like to fund a replacement tree being planted elsewhere on Chautauqua Institution property in-lieu of the replacement tree being located within the front yard ROW for 4 Vincent Ave.
- Variance request for construction of the proposed porch structure to built across the property line, within the ROW.
- Variance from section 5.8.3.2 seeking to exceed the maximum allowed ISR for CI owned ROW land.
  - o Max. allowed for Corner Lots: 0.25, seek permission for: 0.29
  - o This is an improvement from the existing condition of 0.30
- Seeking permission to replace / construction stone block landscape terrace wall on C.I. property per section 5.7.3.7
- Variance from section 5.7.3.8 stipulating a maximum height of retaining walls shall not exceed 2'
  - o Requesting permission to have a maximum height of 30".
  - o Proposed landscape terrace walls shall have a minimum horizontal setback of 4' so as to not require the use of guardrails per NYS Building Code.
- Seeking permission for installing landscaping and entrance walks on C.I. owned ROW land.
- Variance from section 4.3.3 Max Lot Size, Intensity and ISR
  - o Seeking permission to improve the existing building FAR from 2.27 to 2.19 (max. permitted is 1.37)
- Variance from section 4.3.6 Building Setbacks
  - Seeking variance for the existing 0'-0" setback on the Vincent Avenue and North Terrace Avenue property lines as well as the rear yard setback. Also, an existing side yard setback of 1'-10". Partial foundation replacements (both pier and concrete wall type) adjacent to the property lines are requested for basement and porch piers.

#### Option B (Alternate):

- Seeking permission for the removal of the existing ~24" Dia. Maple tree located at the curb line within the front yard right-of-way (ROW). (The tree has a significant lean out over the road and utility lines and the roots are causing displacement of adjacent pavements.)
  - oThe property owner would like to fund a replacement tree being planted elsewhere on Chautauqua Institution property in-lieu of the replacement tree being located within the front yard ROW for 4 Vincent Ave.
- Variance request for construction of the proposed porch structure to built across the property line, within the ROW.
- Seeking permission to replace / construction stone block landscape terrace wall on C.I. property per section 5.7.3.7
- Variance from section 5.7.3.8 stipulating a maximum height of retaining walls shall not exceed 2'
  - o Requesting permission to have a maximum height of 30".
  - o Proposed landscape terrace walls shall have a minimum horizontal setback of 4' so as to not require the use of guardrails per NYS Building Code.
- Seeking permission for installing landscaping and entrance walks on C.I. owned ROW land.
- Variance from section 4.3.3 Max Lot Size, Intensity and ISR
  - Seeking permission to improve the existing building FAR from 2.27 to 2.19 (max. permitted is 1.37)
- Variance from section 4.3.6 Building Setbacks
  - Seeking variance for the existing 0'-0" setback on the Vincent Avenue and North Terrace Avenue
    property lines as well as the rear yard setback. Also, an existing side yard setback of 1'-10". Partial
    foundation replacements (both pier and concrete wall type) adjacent to the property lines are
    requested for basement and porch piers.

Q)	I agree to abide by the Rules & Regulations and Land Use Regulations: X YES	Chautauqua Institution and the ArchitecturalNO
R)	I understand that financial penalties apply for Regulations and I agree to pay such fines if (Refer to Schedule of Penalties. Liens will be place)	
Sch	edule of Penalties (See Regulations):	
For	All Projects	
1.	Failure to Post Compliance Certificate in Visik	ole Location on Property
		\$ 25 / day
	Commencement of Construction Activities prices Certificate of Compliance  Unauthorized Demolition	or to receipt of Chautauqua Institution Max. \$1,000 or \$250 / day Max. \$10,000 or \$100 / day
4	. Construction Site Maintenance	\$100 / day
5	. Failure to Correct Violation	Max. \$1,000 or \$100 / day
6	. Removal of Tree from Institution Property	\$10,000 Max \$5,000 Min. per tree
7	. Removal of Tree from Private Property	\$ 5,000 Max - \$1,000 Min. per tree
Ack	nowledgement:	
Charabov	derstand that by signing this document I agree utauqua Institution and the Architectural and Live information is true and correct to the best of the pay the listed penalties in the instances of 3/2/2/2	and Use Regulations. I also certify that the my knowledge and that I understand and
Sign	5 /2 /23 _ ajure *** Date	Property Owner's
Sigh	ature Date	Prime Contractor / CM's
1000	E: ALL CONTRACTORS MUST HAVE A CER CHAUTAUQUA INSTITUTION PRIOR TO PER DUNDS OF CHAUTAUQUA INSTITUTION.	
Noc	hannes shall be made in such work that deviate	e from that submitted without the prior

No changes shall be made in such work that deviate from that submitted without the prior approval of the Institution. The issuance of a Compliance Certificate is in addition to and not in substitution for required building permits issued by appropriate governmental authorities, especially the Town of Chautauqua and the Chautauqua Utility District.

#### **COMPLIANCE CERTIFICATE REVIEW FEES:**

All exterior or interior remodeling \$35
Additions to existing buildings \$90
New construction and substantial rehabilitation \$200
All cases going to the ARB \$310

Note: Fees are reviewed annually by the Board of Trustees and may change without notice.

#### **IMPORTANT CONTACT INFORMATION:**

Operations Office:	P.O. Box 28	716-357-6245

Chautauqua, NY 14722 (fax) 716-357-9014

Jennifer Majewski Administrative Assistant 716-357-6245

jmajewski@chq.org

Administrator of Architectural and Land Use Regulations 716-357-6400

& Capital Projects Manager

Jack Munella Manager of Buildings and Grounds 716-357-6237

imunella@chq.org

Betsy Burgeson Gardens Supervisor (Trees) 716-357-6326

bburgeson@chq.org

Amy Hummel Buildings/Grounds/Gardens Assistant 716-357-6208

ahummel@chq.org

Chautauqua Institution Security:

Joe Gerace Chief of Police 716-357-6225

Town of Chautauqua:

Jeff Paddock Code Enforcement Officer 716-753-3433

Other:

Chautauqua Utility District Office 716-357-5865
CUD Wastewater Management 716-357-8137

NY State Call Before You Dig 811

Website link: www.chq.org/construction-resources

#### ALL DOCUMENTS ARE AVAILABLE TO DOWNLOAD ON OUR WEBSITE

Applications shall be filed with the Architectural and Land Use Administrator of Chautauqua Institution. The following information must be included:

- **6.1.1. Standard Application Requirements** For New Construction, a Building Project or a Landscaping Project, the application, signed by the Applicant, shall be accompanied by seven (7) sets of the following:
  - (a) scaled, dimensional drawings of the project (minimum 1/8" = 1'-0");
  - (b) an official survey of the Lot, showing (i) Lot dimensions, (ii) Lot orientation, (iii) the location, size, and material description of all existing and all proposed Structures, walkways, drives, retaining walls, garden walls, fences, patios, decks, Ancillary Equipment (including air conditioning units and compressors and generators), and other site amenities (including locations for garbage and recycling containers) in relation to the street, to other Buildings and Structures (both in terms of height profiles and land footprints), and to Lot and Setback lines, (iv) pre- and post-project contours in one foot increments, and (v) the location of existing trees, bushes, vegetation and other plants both on the Lot and in the adjacent right of way, with the designation of any trees that are proposed to be removed or that will be within ten (10) feet of any construction or excavation;
  - (c) site plan (to the extent not shown on the official survey provided for in clause (b) above);
  - (d) floor plans for each floor or Story, including any Basement or proposed Basement;
  - (e) roof plan;
  - (f) front, rear, and side elevations identifying materials, dimensions, heights, and types of windows and doors;
  - (g) details of door and window types (to the extent not provided for in clause (f) above), steps, railings, driveways, and walkways;
  - (g) streetscapes showing both the existing Structure and the post-project proposed Structure;
  - (h) landscaping details, including a drainage and storm water management plan; and

(i) such additional documents, drawings, or information as the Administrator may reasonably request.

The Administrator may in his sole and absolute discretion accept an application as complete without requiring the submission of one or more of the foregoing items based on the Administrator's evaluation of the nature, extent, and complexity of the proposed New Construction, Building Project, or Landscaping Project; provided, however, the Administrator's decision to proceed on that basis shall not be binding on the ARB in those instances in which ARB review or approval of an application are required (whether by reason of appeal of the Administrator's decision or otherwise) and the ARB in its discretion may require submission of any one or more of the omitted items as a condition to its review or approval of an application.

- **6.1.2. Basic Diagrams** For New Construction or a Building Project, including a Building Project that includes only minor alterations to windows, doors, porches, dormers or the like (but no Additions or structural changes to the Building), or for replacements thereof, the application shall contain basic diagrams drawn to scale showing both the existing and the proposed alterations/replacements.
- **6.1.3. Elevations and Scale Drawings** For New Construction or a Building Project, the application shall contain such information as will demonstrate compliance with the requirements of these Regulations, including Article 4 and Article 5 hereof, which information shall include, but not be limited to, scale drawings of all exterior Elevations with dimensions showing both the Building Height and the Building Footprint, pre- and post-project FAR and ISR calculations, explanatory sections, details of door and window types, porch steps and railings, details of Building finishes, baseline grade and elevation calculations for the Lot, and an indication of finished floor and ceiling levels.
- **6.1.4.** Additional Drawings and Information The application shall also contain such additional drawings, information and diagrams as may reasonably be requested by the Administrator or the ARB to ensure compliance with these Regulations, including, without limitation, streetscapes.
- **6.1.5.** Certificate Regarding Variances and Special Exception The application shall contain the written, signed certification of the Applicant that either (a) certifies that the proposed project requires no Variance or Special Exception from these Regulations or (b) specifies the Variances and Special Exceptions from these Regulations required for the proposed project and certifies that, other than the specified Variances and Special Exceptions, the proposed project requires no other Variance or Special Exception from these Regulations.
- **6.1.6. Certification of Completeness** Prior to the issuance of a Compliance Certificate by the Administrator, the Applicant shall certify in writing to the Administrator that all documents delivered by or on behalf of the Applicant to the Administrator and the ARB in connection with the application are identical to those that have been submitted to the Town of Chautauqua in connection with its building permit review, and the Applicant subsequent to the issuance of the Compliance Certificate shall deliver to the Administrator from time to time such supplemental or additional documents as shall be needed to ensure continued compliance with this requirement.
- **6.1.7. Condition Precedent to Construction** Work on New Construction, a Building Project, a Landscaping Project or Demolition shall not be commenced until the required Compliance Certificate has been issued by the Administrator.
- **6.1.8.** Need for Supplemental Approval No changes shall be made in the scope or nature of the New Construction, Building Project, Landscaping Project, or Demolition that deviate materially from the project as previously approved by the Administrator or the ARB without the prior written approval of the Administrator obtained after a supplemental written application from the Applicant. The Administrator shall determine whether or not the supplemental written application requires review and approval by the

ARB or whether the supplemental written application is within his power to review and approve. If the Administrator determines that the supplemental written application is within his power to review and approve and if the Administrator denies that application or approves that application with conditions, then the Applicant may appeal the Administrator's decision to the ARB in the manner set forth herein.

**6.1.9. Other Permits** The requirement of a Compliance Certificate is in addition to and not in substitution for required building, demolition (and other) permits issued by appropriate governmental authorities having jurisdiction over the subject matter of any Compliance Certificate.Notwithstanding the issuance of a Compliance Certificate subsequent to the approval of an application by either the Administrator or the ARB, it remains the responsibility of the Applicant and the Applicant's contractor and other agents to comply fully and completely with all relevant requirements of the rules, regulations, and codes of New York State, the Town of Chautauqua, and all other governmental authorities having jurisdiction over the subject matter of the Compliance Certificate.

CHAUTAUQUA INSTIT	UTION COM	IPLIANCE PRO	OCESS MATRIX
ACTION		REVIEWING AUTHO	PRITY
	NO APPLICATION OR COMPLIANCE CERTIFICATE REQUIRED (CONSIDERED MAINTENANCE)	REVIEW AND APPROVAL BY THE ADMINISTRATOR FOLLOWED BY ISSUANCE OF A COMPLIANCE CERTIFICATE.	REVIEW AND APPROVAL BY THE ARB FOLLOWED BY ISSUANCE OF A COMPLIANCE CERTIFICATE BY THE ADMINISTRATOR.  *When a Variance to any regulation or criteria is requested or required.
		*Provided no Variance to any regulation or criteria is requested or required.	
NEW CONSTRUCTION AND BUILDING PREHABILITATIONS, RENOVATIONS, RESERVED AND APPROVAL CONTROL OF THE PROPERTY OF	STORATIONS, AND	SUBSTANTIAL REHABIL	LITATIONS, BUT
COMPLIANT WITH ALL REQUIREMENTS		X	
MINOR ENCROACHMENT ONLY		X	
VARIANCE OR SPECIAL EXCEPTION REQUESTED OR REQUIRED			X
DEMOLITIONS, INCLUDING REVIEW AN LANDSCAPING	D APPROVAL OF PO	OST-DEMOLITION STRU	CTURES AND RELATED
ACCESSORY STRUCTURE			X
PRIMARY STRUCTURE			X
DEMOLITION TO CREATE OPENINGS BETWEEN EXISTING AND APPROVED NEW CONSTRUCTION WHEN NOT VISIBLE FROM THE EXTERIOR OF THE COMPLETED PROJECT		X	
INVESTIGATIVE DEMOLITION		X	

BUILDING CODE/FIRE CODE COMPLIANCE AND RELATED ISSUES OF SAFETY AFTER A FIRE OR OTHER CASUALTY		X	
DRIVEWAYS			
ADDING A DRIVEWAY		X*	X*
CHANGE OF MATERIAL		X	
REMOVAL OF DRIVEWAY		X	
FOUNDATIONS			
REPAIR IN KIND		X	
ADDITION OF A FOUNDATION, BUT WITH THE SAME FIRST-FLOOR ELEVATION		X	
ADDITION OF A FOUNDATION, BUT WITH A CHANGE OF FIRST-FLOOR ELEVATION		X*	X *
ADDITION OF A BASEMENT		X*	X *
ALTERATION OR CHANGE OF WINDOWS	3		
SAME LOCATION, MATERIAL, AND DESIGN		X	
DIFFERENT LOCATION, MATERIAL OR DESIGN WHEN COMPLIANT WITH THE SELECTED ARCHITECTURAL STYLE OF THE PROJECT		X	
DIFFERENT LOCATION, MATERIAL OR DESIGN WHEN <u>NOT</u> COMPLIANT WITH THE SELECTED ARCHITECTURAL STYLE OF THE PROJECT			X
MUNTINS ON EXTERIOR OF GLASS		X	
MUNTINS ON INTERIOR OF GLASS			X
PORCHES / BALCONIES / DECKS / PATIOS	S / PERGOLAS		
COMPLIANT WITH ALL REQUIREMENTS		X	
VARIANCE REQUESTED OR REQUIRED			X
SITE FEATURES / LANDSCAPING			
SHEDS		X*	X*
FENCES / GARDEN WALLS / RETAINING WALLS		X*	X*
POOLS / SPAS		X*	X*
CHANGE OF PLANT MATERIAL	X		
CHANGE OF GRADE		X*	X*
CANVAS AWNINGS			
NEW INSTALLATION		X*	X*
OFF-SEASON PORCH PROTECTION	X		
CLEANING			

PRESSURE WASHING	X		
CHEMICAL REMOVAL	X		
SANDBLASTING		X	
INTERIOR MAINTENANCE			
CARPET/FLOORING	X		
WALL FINISHES	X		
PAINTING	X		
INTERIOR ALTERATIONS			
NONSTRUCTURAL CHANGES	X		
STRUCTURAL CHANGES		X	
KITCHEN BATH ALTERATIONS OR APPLIANCE CHANGES	X		
MECHANICAL SYSTEMS			
INTERIOR MECHANICAL SYSTEMS ONLY	X		
SOME (OR ALL) EXTERIOR MECHANICAL SYSTEMS		X	
AC WINDOW UNITS		X	
AC CONDENSER		X	
GENERATOR		X*	X*
SOLAR PANELS		X*	X *
WIND TURBINE		X*	X *
PAINTING			
EXTERIOR	X		
ROOF			
SAME OR CHANGE OF MATERIAL		X	
SHUTTERS			
REPAIR/REPLACE WITH SAME SIZE, MATERIAL, OR DESIGN	X		
REPAIR/REPLACE WITH DIFFERENT SIZE, MATERIAL, OR DESIGN		X	
NEW		X	