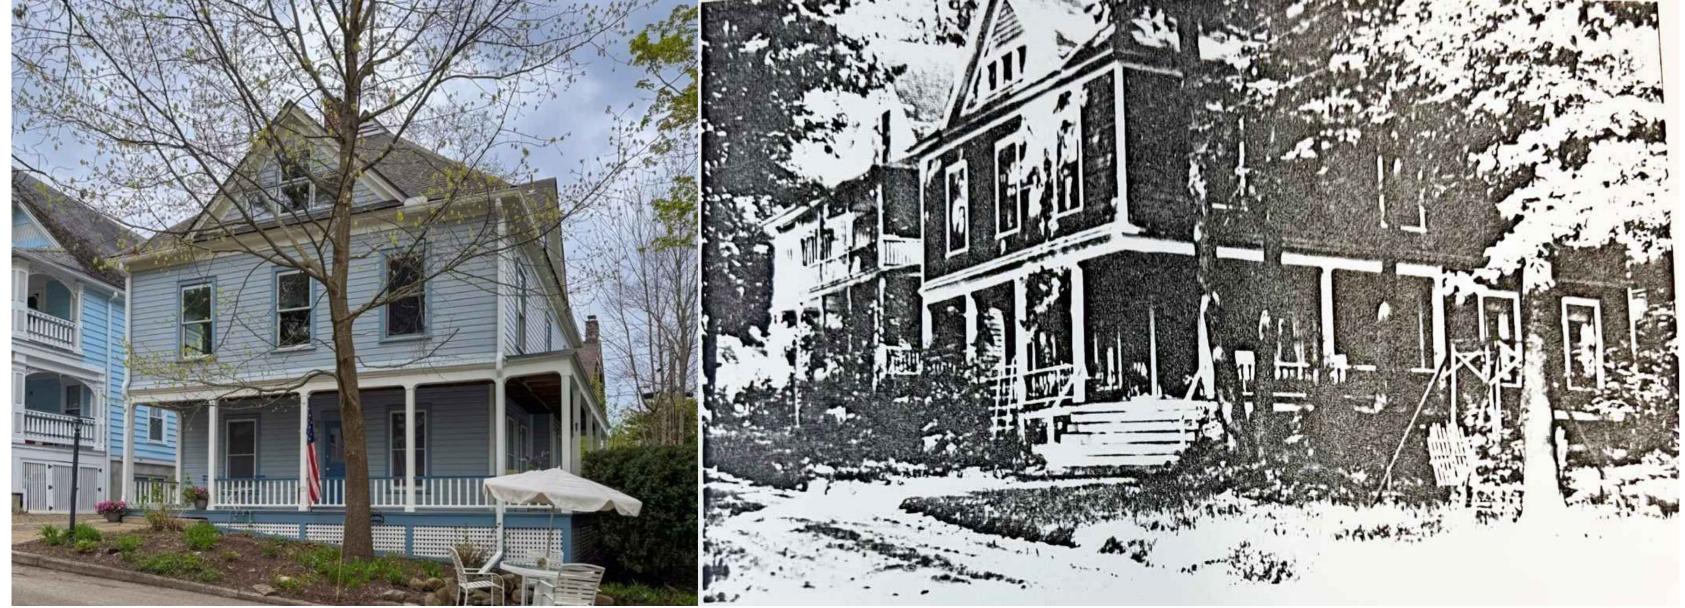


#### 1 A.01

#### **Front Elevation**

1/4" = 1'-0'





#### **Current Facade**

NITS



#### **Archival Image**



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soyan Residenc

### Job Number

2422

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**Drawn By** 

25.03.11 Client Meeting 25.05.01 Client Meeting 25.05.16 Prelim Submission

**Drawing Title** 

Title Sheet

Drawing Number

Leah and William Boyan

**Project Description** 

The project scope includes the renovation of an existing house. The house was stripped of all interior finishes by the previous

wraparound porch that is stylistically compatible to what was originally on the house. This can be seen from early reference images

The current size and location of the home in a Neighborhood Traditional district is causing us to seek clarifications on potential

• Use matrix 4.1 lists parking as allowing as "accessory to use" We have designed the project to allow for a single covered

space adjacent to the house. Open parking space is required to be 18" from the lot line. An enclosed bay parking space is

• The wraparound porch is able to further conceal a car if a variance is allowed for the interior side yard setback requirement on the east side of the lot (4.4.6). The side yard setback is 10' and any porch lies within that setback including the existing porch. Rebuilding or restoring the existing is grandfathered/allowed in the current code. The existing porch is roughly four feet within the setback and six feet from the lot line. The proposed porch is 8'-10' into the setback and 1'-2" from the lot line. This variance

• In an effort to allow for this parking space, and to keep it concealed beneath a wraparound porch, we raised the first floor of

• We seek a variance on the FAR maximum (4.4.3) from 1.0 to 1.06. The house was slightly overbuilt before any new was

• The house has previously operated as a hotel/boarding house/rooming house. In the absence of current commercial use

short term stays. Under the Single-family use classification, we are able to permit this as a "bed and breakfast" in the

shown for the home, The owners intend to renovate the home with a primary unit for themselves and 3 units for guests for

**Project Area** 

New Bsmnt Floor Area

exempt from FAR calc

EXG First Floor Area:

New First Floor Area

EXG Attic Floor Area: New Attic Floor Area:

exempt from FAR calc

At-grade footprint

ISR Ratio

50.7%<65% of at-grade footprint

Total SF

Total FAR

EXG Second Floor Area:

988 sf

960

2120 sf

1.06 sf

1628

**Structural Engineer** 

Rock Hill Engineering

rockhill6948@gmail.com

Peter Radka

716-782-2206

28

planned and we are adding an additional 28 SF for a closet and circulation space within the house.

40 psf

30 psf

10 psf

30 psf

12 psf

Contractor

Name: TBD

Company

Phone number

the house roughly 18". We will seek a variance to allow for the added roof height over 36' stipulated in (4.4.5) to 38'-8". Please note, the original house roof was at 37'-2" in height to the highest point before and modification. All heights are approximate. Surveying needs to include topography and floor heights. 18" is the code max allowed in adding a basement. The first floor is required to be no more than thee feet over grade after modifications and we are at 4' roughly. (5.1.5). This variance needs to be

owners and the current owners seek to renovate the home with improvements. These improvements include an expanded

of the home. It also includes a single covered parking spot under the porch for the owners of the home.

variances as we proceed with the project. These items are listed below.

reviewed and approved by the board. The sloping lot is a practical difficulty.

"B"

115

included in our proposed side yard setback variance.

needs to be reviewed and approved by the board.

neighborhood traditional district.

**Design Loads** 

Seismic Design Category:

Wind Speed (mph):

Floor Live Loads:

First Floor:

Second Floor: Floor Dead Loads:

2. Roof Live Loads (snow):

**Total Roof Loading:** 

**Project Team** 

George Clemens Architecture

Project Lead: Jordan Meerdink

george@clemensarchitecture.com jordan@clemensarchitecture.com

**Index of Drawings** 

Title Sheet

A0.3 Ex'g Floor Plans

A0.4 Ex'g Elevations

A0.5 Ex'g Elevations

A0.2 Ex'g Site Plan, Ex'g Floor Plan

**Proposed Floor Plans** 

**Proposed Floor Plans** 

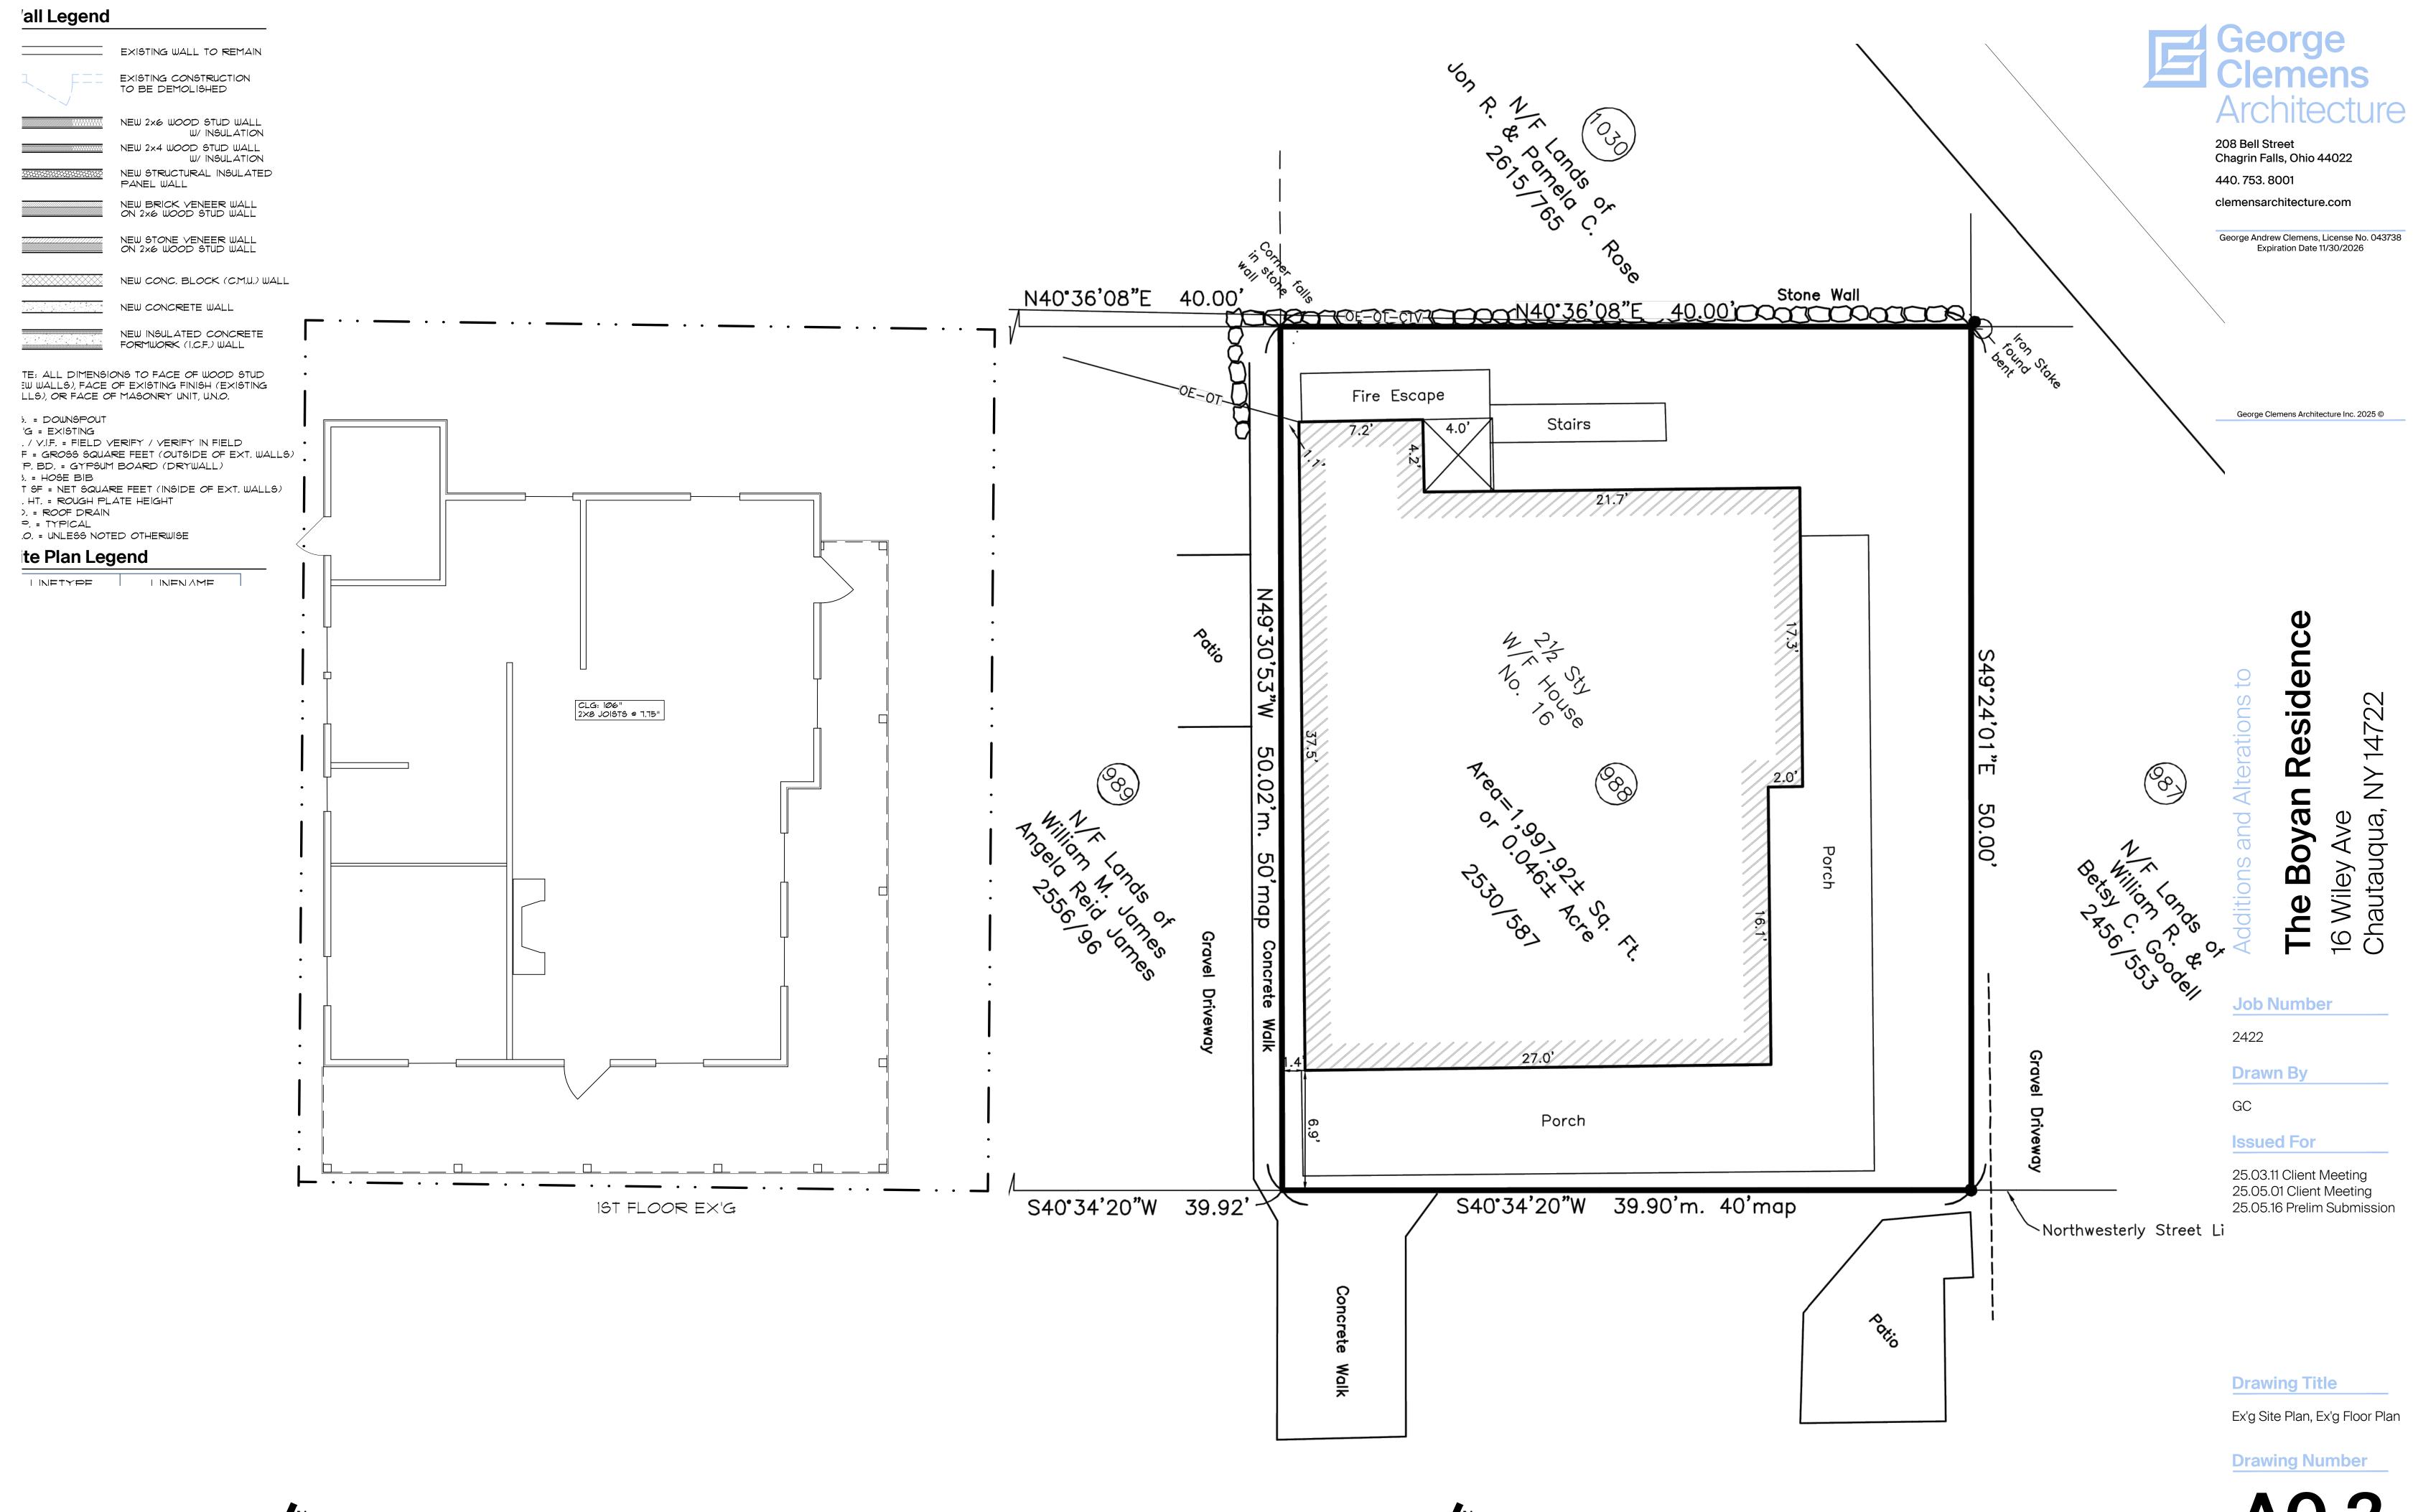
**Proposed Elevations** 

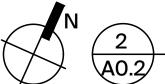
**A2.2** Proposed Elevations

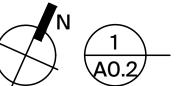
Architect George Clemens

440-753-8001

Roof/Ceiling Dead Load:









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**The Boyan Residence**16 Wiley Ave
Chautauqua, NY 14722

**Job Number** 

2422

**Drawn By** 

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**Drawing Title** 

Proposed Elevations



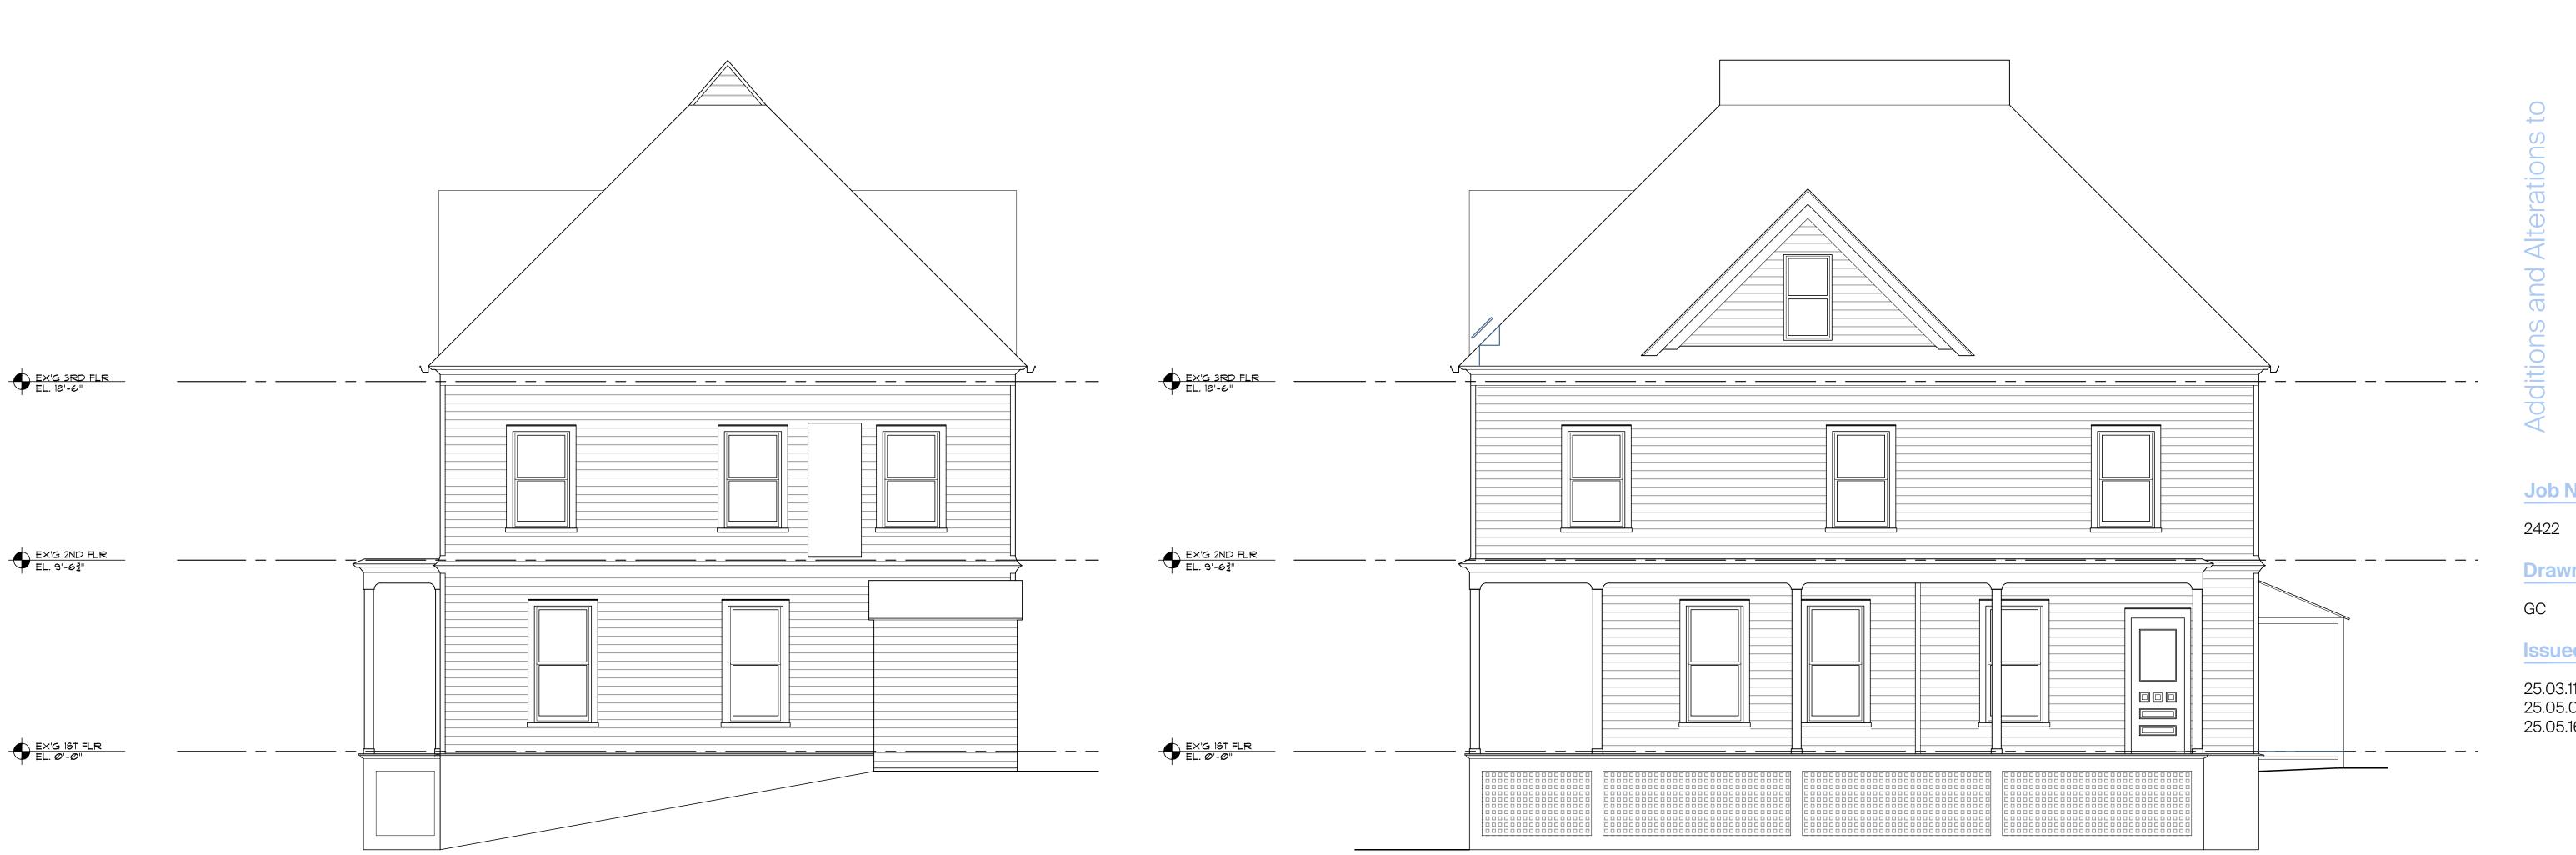


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**Drawing Title** 

Proposed Elevations

#### Wall Legend

EXISTING WALL TO REMAIN EXISTING CONSTRUCTION TO BE DEMOLISHED NEW 2x6 WOOD STUD WALL W/ INSULATION NEW 2x4 WOOD STUD WALL W/ INSULATION NEW STRUCTURAL INSULATED PANEL WALL NEW BRICK VENEER WALL ON 2×6 WOOD STUD WALL NEW STONE VENEER WALL ON 2×6 WOOD STUD WALL NEW CONC. BLOCK (C.M.U.) WALL NEW CONCRETE WALL NEW INSULATED CONCRETE FORMWORK (I.C.F.) WALL

NOTE: ALL DIMENSIONS TO FACE OF WOOD STUD (NEW WALLS), FACE OF EXISTING FINISH (EXISTING WALLS), OR FACE OF MASONRY UNIT, UN.O.

D.S. = DOWNSPOUT EX'G = EXISTING

F.V. / V.I.F. = FIELD VERIFY / VERIFY IN FIELD GSF = GROSS SQUARE FEET (OUTSIDE OF EXT. WALLS)


GYP. BD. = GYPSUM BOARD (DRYWALL) H.B. = HOSE BIB NET SF = NET SQUARE FEET (INSIDE OF EXT. WALLS) PL. HT. = ROUGH PLATE HEIGHT

R.D. = ROOF DRAIN TYP. = TYPICAL

U.N.O. = UNLESS NOTED OTHERWISE

#### Site Plan Legend

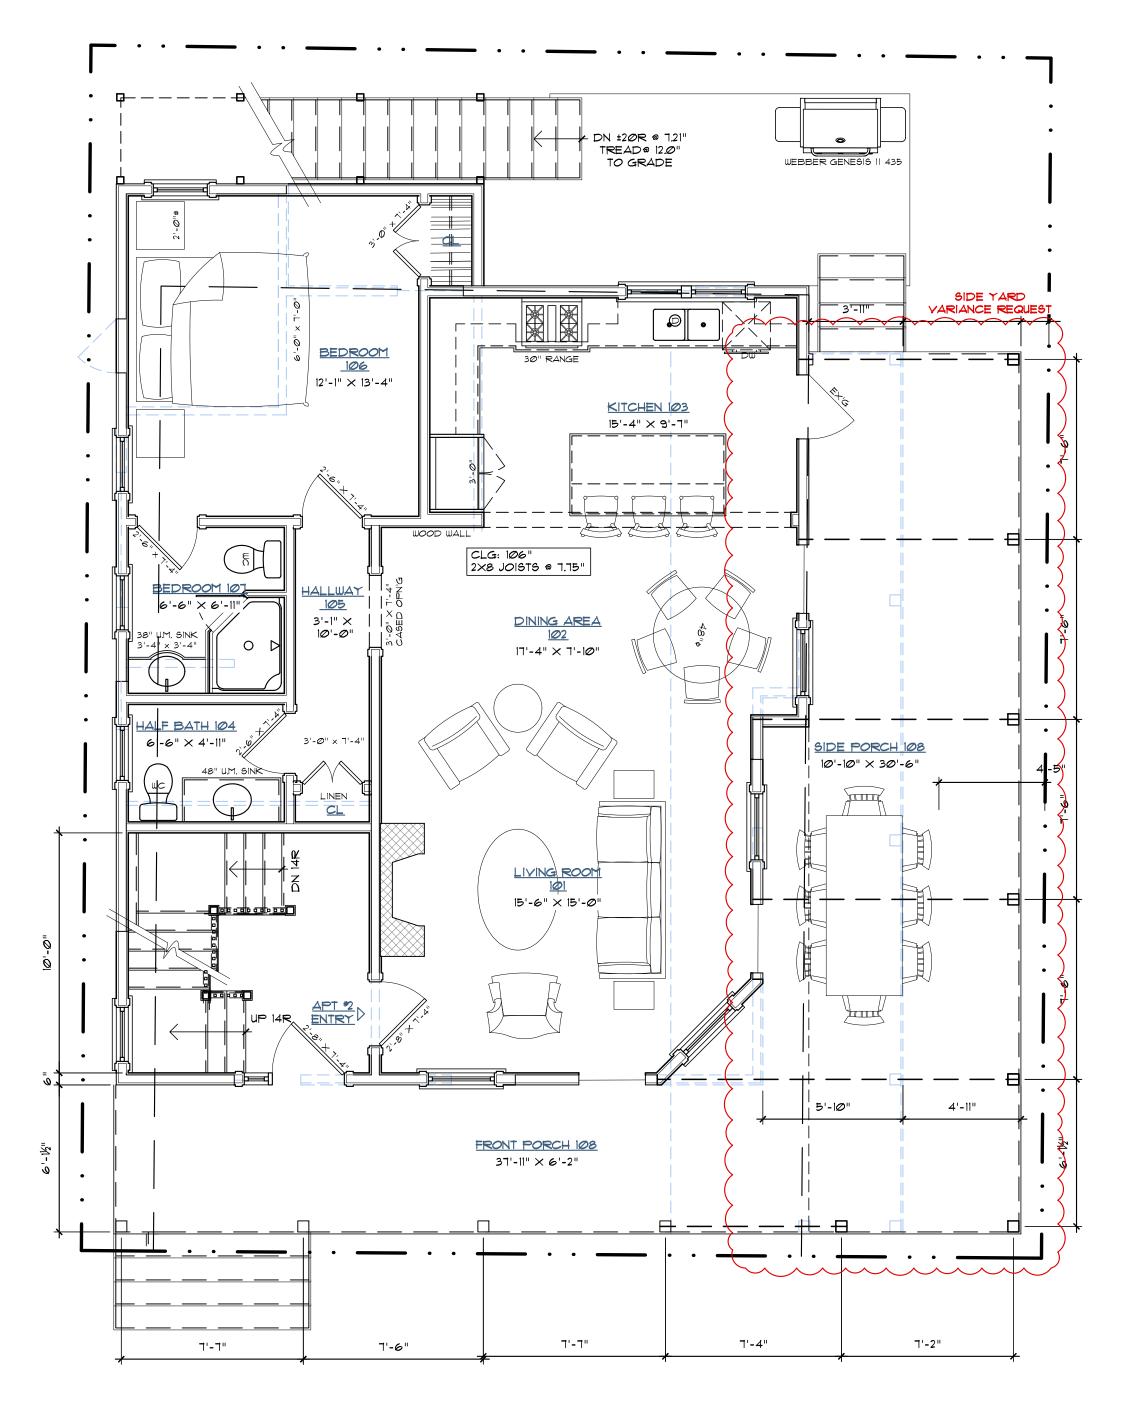LINETYPE  LINENAME  O  Anno-Cl  Site-Bldg  Site-Exst  Site-Fence  Site-Hatch  Site-Misc  Site-Pave  Site-Plant  Site-Plant  Site-Prop  Site-Road  Site-Setback  Site-Topo  Site-Walk	Site Plan Legend		
Anno-Cl Site-Bldg Site-Exst Site-Fence Site-Hatch Site-Misc Site-Pave Site-Plant Site-Prop Site-Road Site-Setback Site-Topo	LINETYPE	LINENAME	
		Anno-Cl Site-Bldg Site-Exst Site-Fence Site-Hatch Site-Misc Site-Pave Site-Plant Site-Prop Site-Road Site-Setback Site-Topo	





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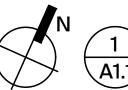
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**Drawing Title** 

Proposed Floor Plans

**Drawing Number** 







DN ±2ØR @ 7.21" TREAD@ 12.0"

30" RANGE

TO GRADE

2'-Ø"

KITCHEN AREA \_\_\_<u>15'-4" × 8'-5"</u> \_\_

<u>LIVING AREA</u> <u>009</u> 16'-8" × 12'-5"

HVAC ROOM 2003 4'-4" × 4'-10"

BACK HALLWAY 002 14'-2" × 4'-3"

WEBBER GENESIS II 435

SIDE YARD VARIANCE REQUEST

PERVIOUS
PAVERS UNDER
PORCH

BEDROOM

<u>007</u>

11'-Ø" ×

APT \*

EN-SUITE

<u>BATH</u> <u>006</u> 5'-9" × 8'-9"

HALF BATH

205
5'-10" × 4'-3"

#### Wall Legend

EXISTING WALL TO REMAIN EXISTING CONSTRUCTION TO BE DEMOLISHED NEW 2x6 WOOD STUD WALL W/ INSULATION NEW 2x4 WOOD STUD WALL W/ INSULATION NEW STRUCTURAL INSULATED PANEL WALL NEW BRICK VENEER WALL ON 2×6 WOOD STUD WALL NEW STONE VENEER WALL ON 2×6 WOOD STUD WALL NEW CONC. BLOCK (C.M.U.) WALL NEW CONCRETE WALL NEW INSULATED CONCRETE FORMWORK (I.C.F.) WALL

NOTE: ALL DIMENSIONS TO FACE OF WOOD STUD (NEW WALLS), FACE OF EXISTING FINISH (EXISTING WALLS), OR FACE OF MASONRY UNIT, U.N.O.

D.S. = DOWNSPOUT  $E \times G = E \times STING$ 

F.V. / V.I.F. = FIELD VERIFY / VERIFY IN FIELD

GSF = GROSS SQUARE FEET (OUTSIDE OF EXT. WALLS) GYP. BD. = GYPSUM BOARD (DRYWALL)

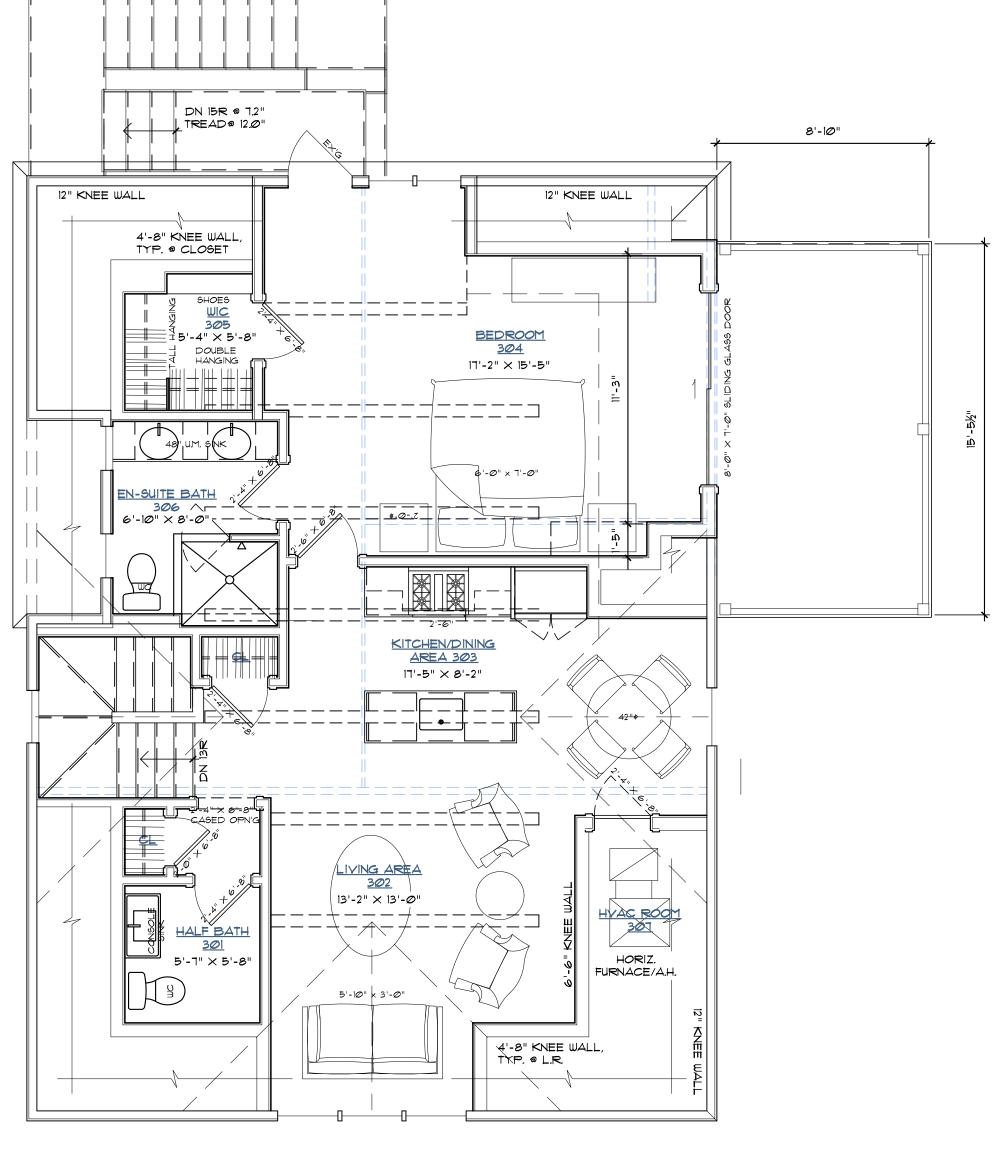
H.B. = HOSE BIB

NET SF = NET SQUARE FEET (INSIDE OF EXT. WALLS)

PL. HT. = ROUGH PLATE HEIGHT R.D. = ROOF DRAIN

TYP. = TYPICAL U.N.O. = UNLESS NOTED OTHERWISE

#### Site Plan Legend





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# ence

8'-10"

2'-Ø"#

6'-0" x 7'-0"

BEDROOM 2

206  $12'-4" \times 10'-10"$ 

CLG: 100.5"

2×6 JOISTS @ 5.75"

KITCHEN 203

LIVING ROOM 202

 $17'-3" \times 12'-4"$ 

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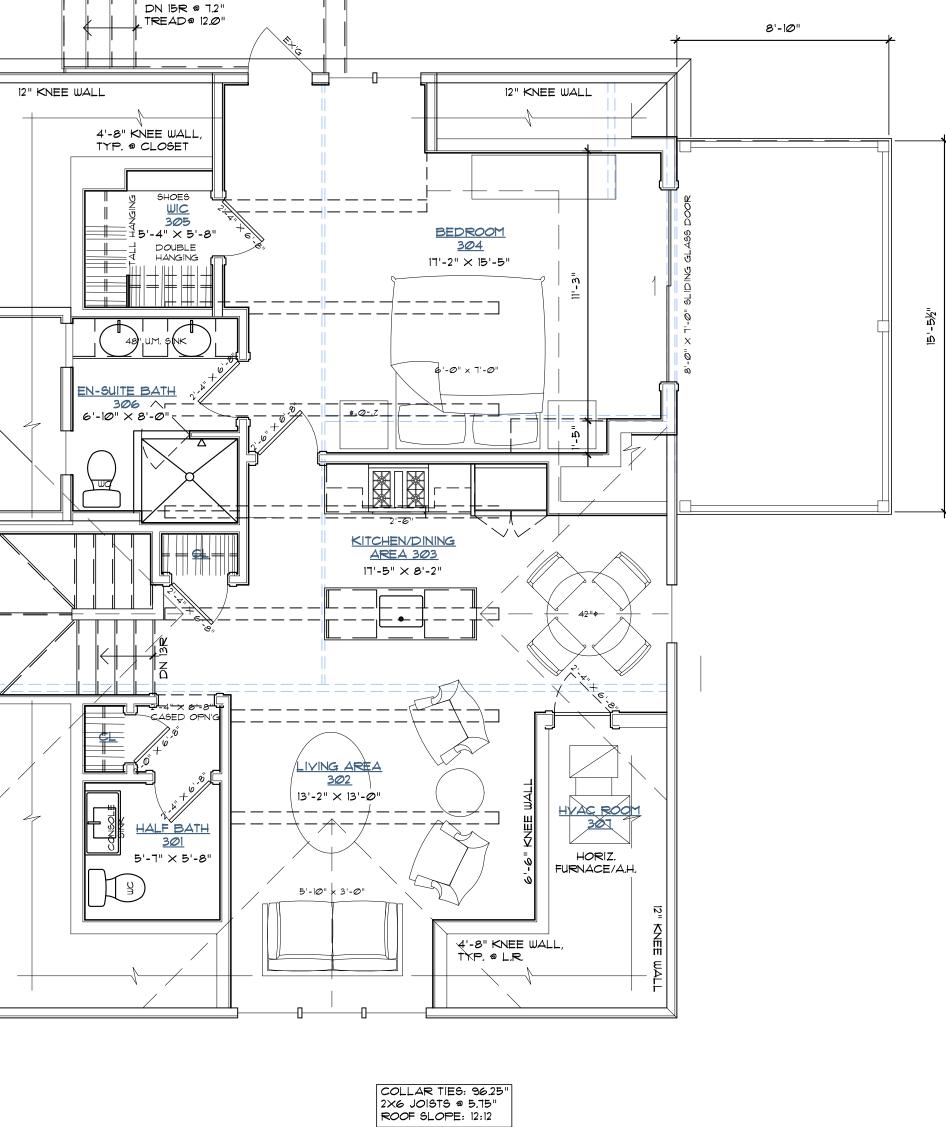
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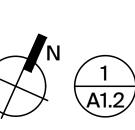
**Drawing Title** 

Proposed Floor Plans

**Drawing Number** 









DN ±20R @ 7.21"

APT \*3 ENTRY

DINING AREA 201 10'-5" × 9'-0"

New Second Floor Plan

1/4" = 1'-0"

TREAD® 12.0"

TO GRADE

MASTER BEDROOM 2010

12'-11" × 12'-10"

EN-SUITE BATH 208 12'-11" X 5'-0" 0

UP 15R @ 7.2"

TREAD® 12.0"

<u>PANTRY</u> <u>204</u> 17'-3" × 5'-6"

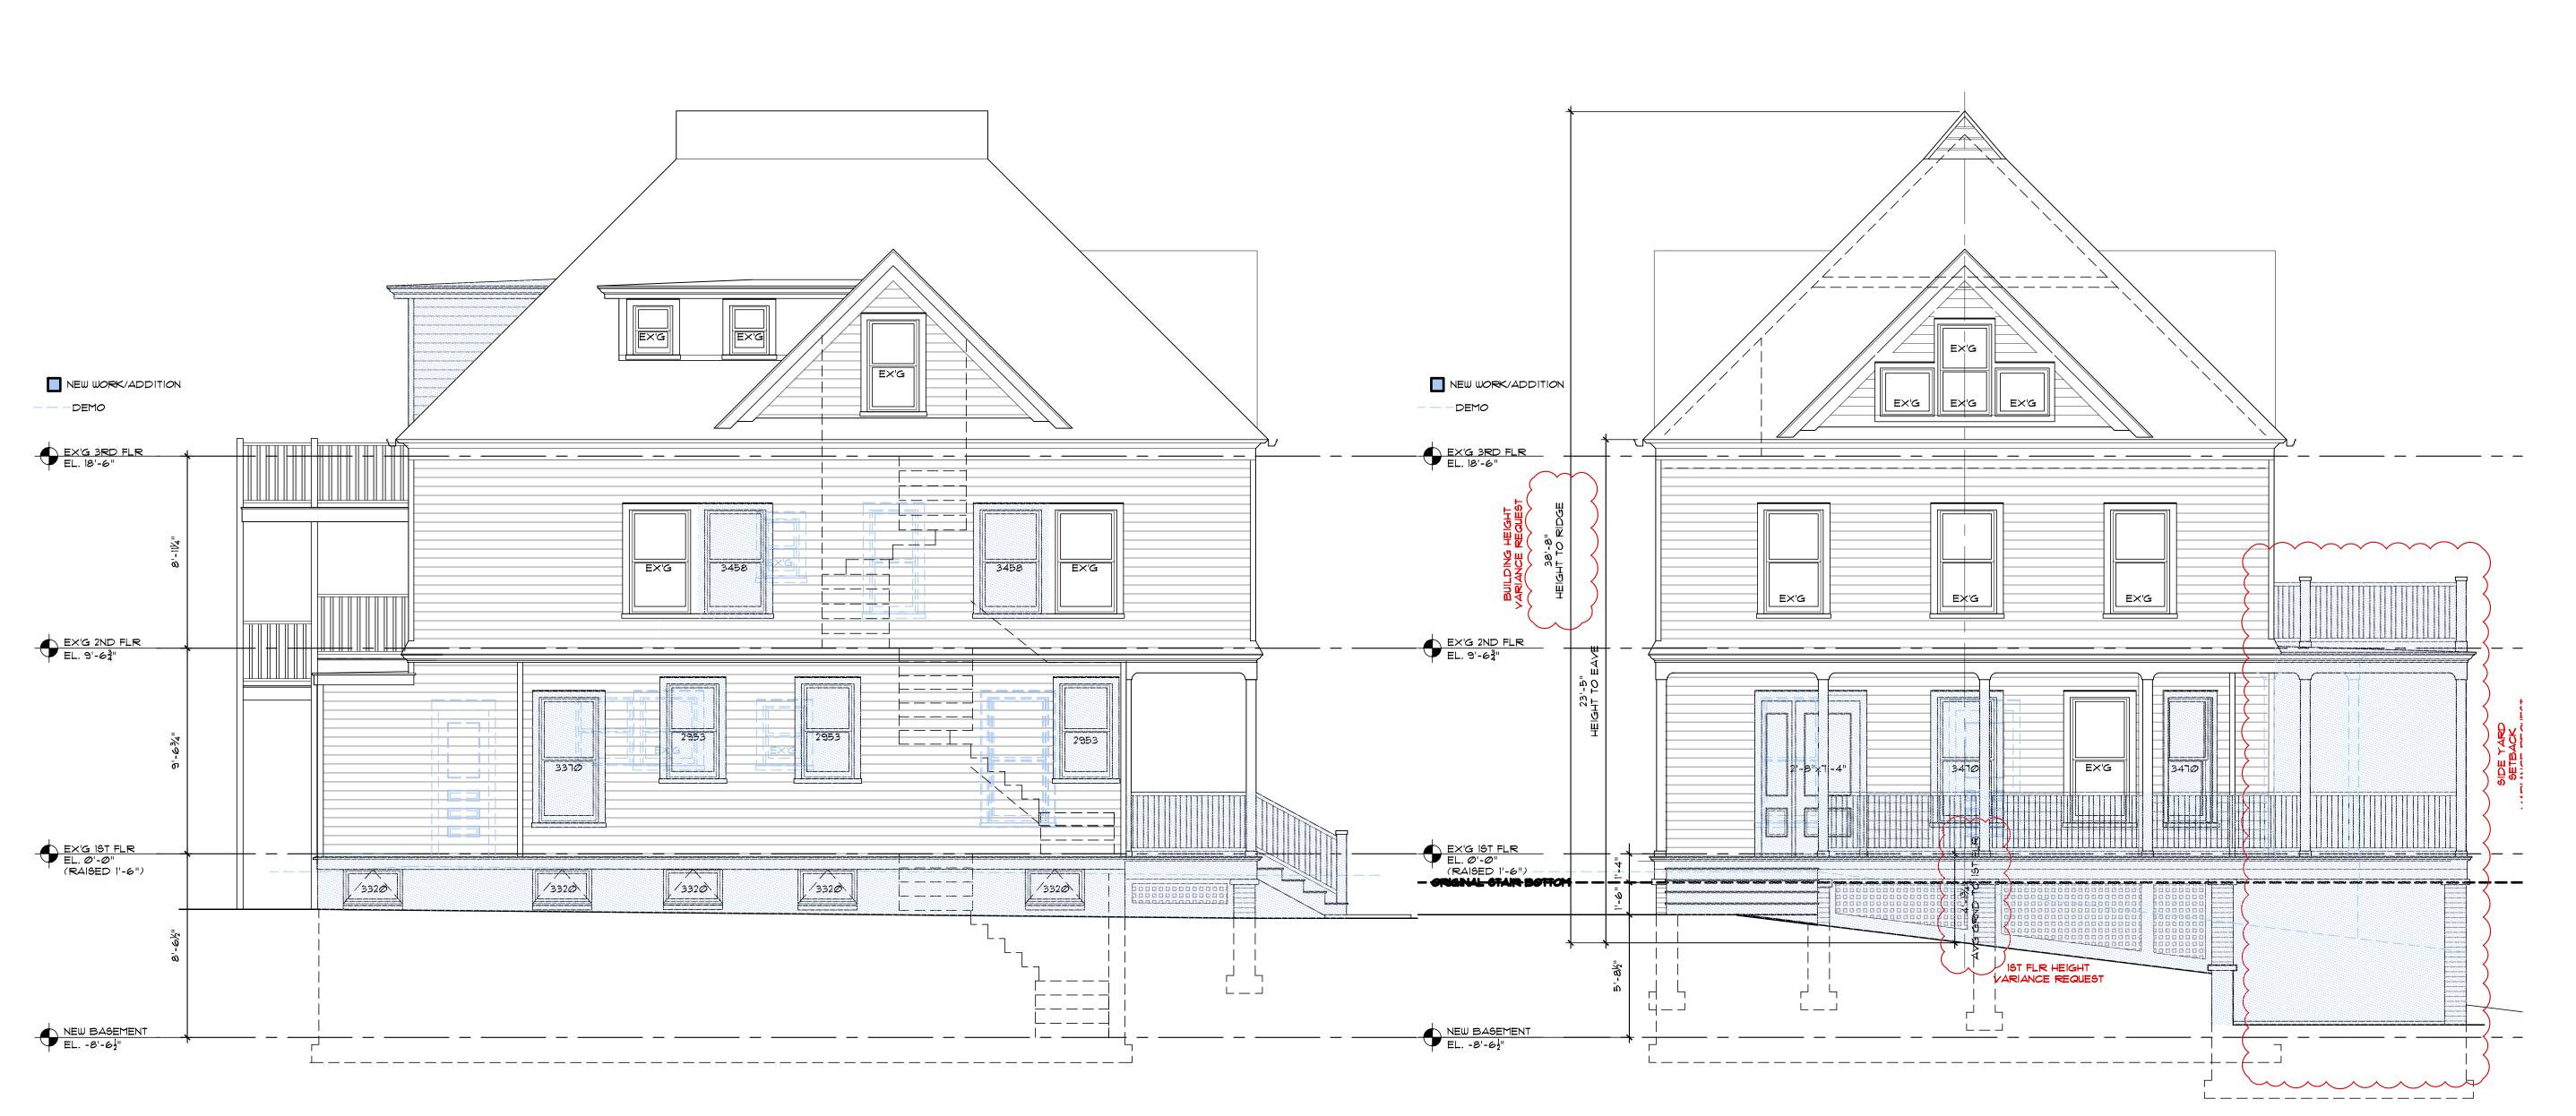


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**Drawing Title** 

Proposed Elevations



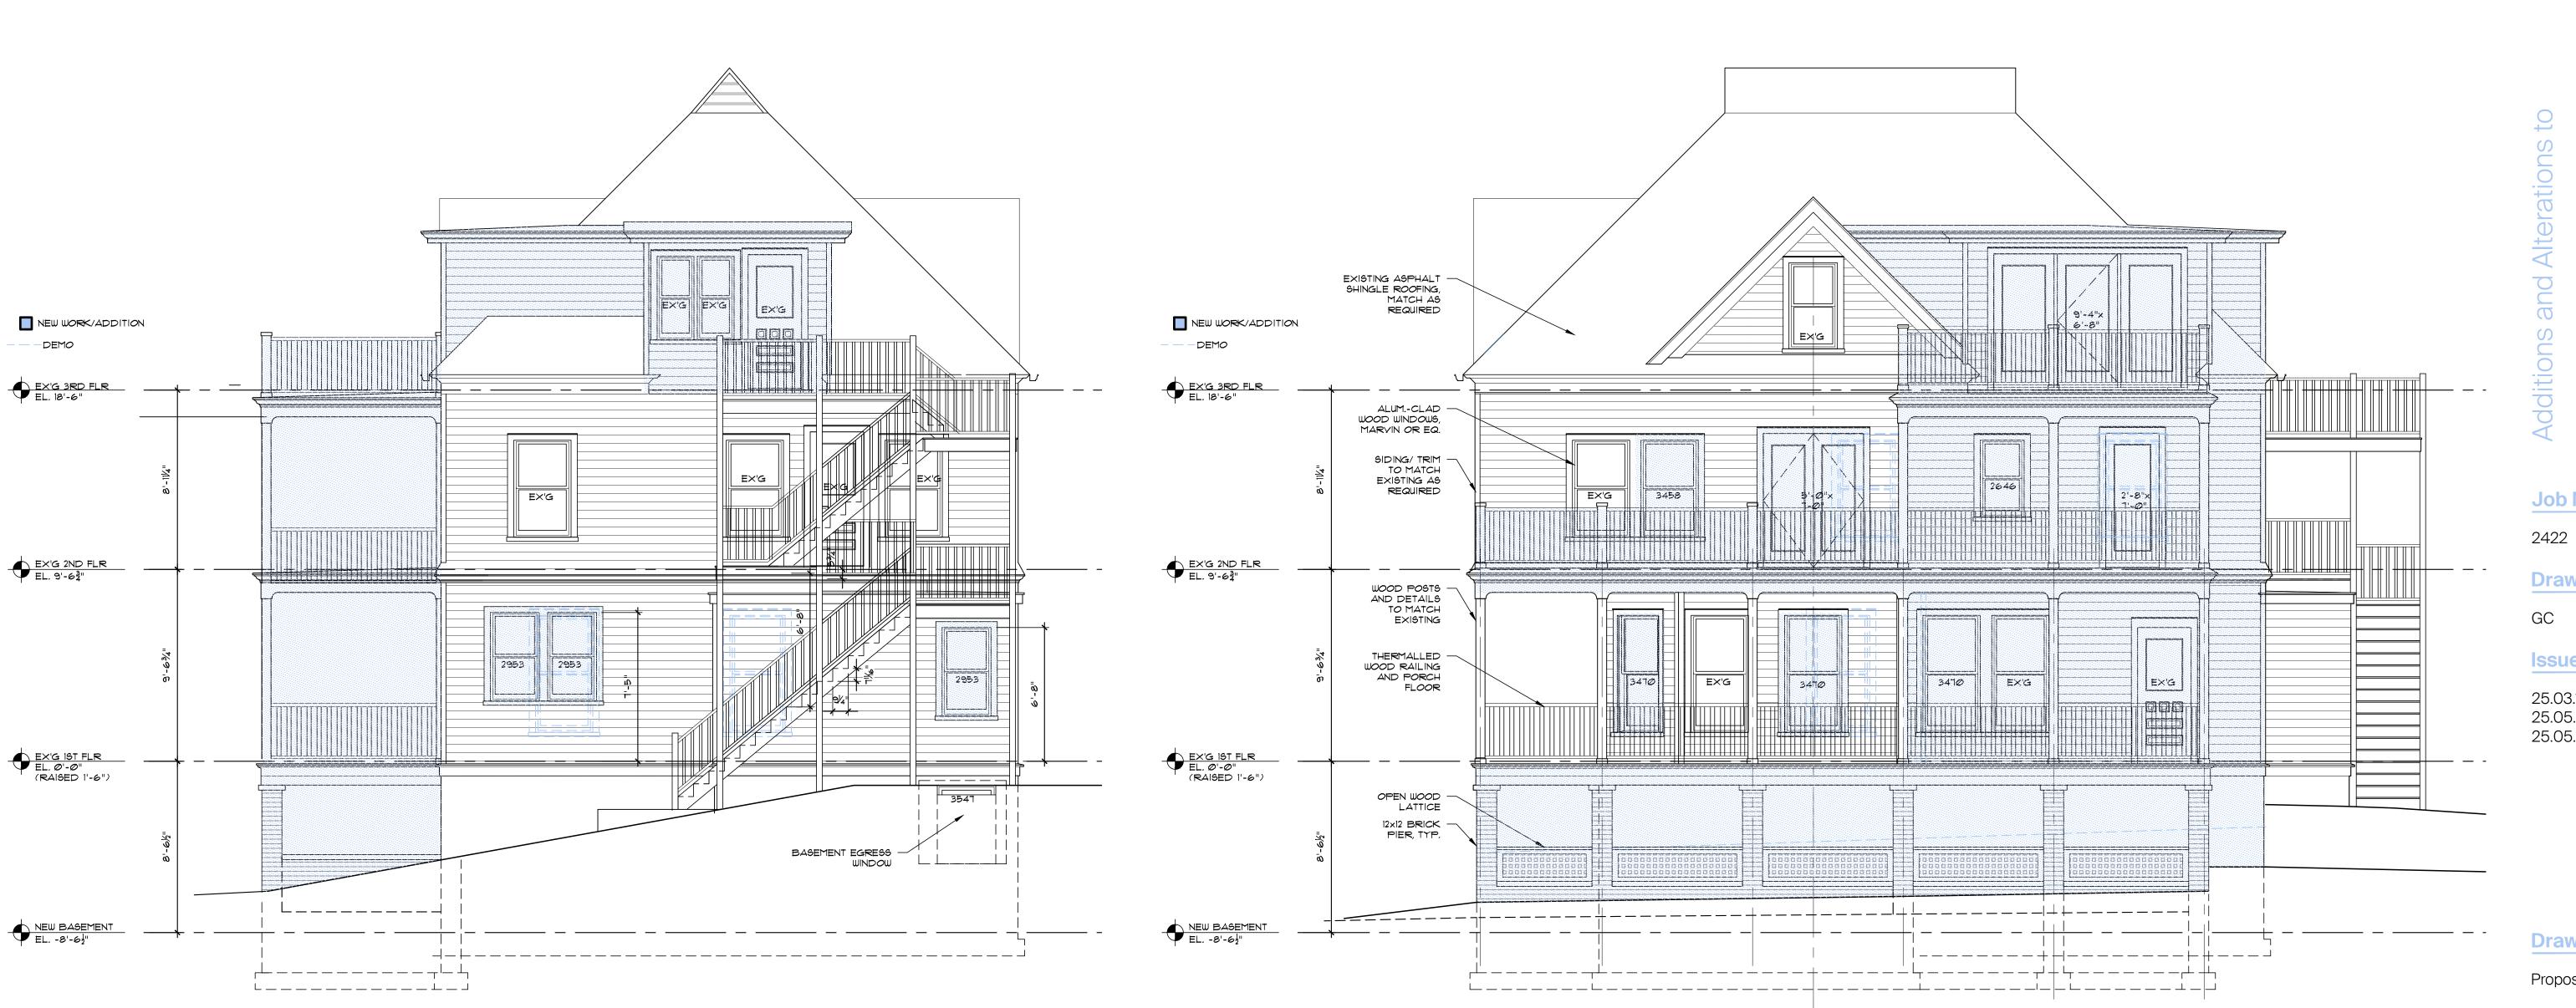
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Proposed Elevations